**BUSINESS CUSTOMERS - NEW SERVICE** 

**VERIZON COMMUNICATIONS - NJ** 

SOUTH PLAINFIELD, NJ 07080

COMCAST CABLEVISION 800 RAHWAY AVENUE

**CONSTRUCTION & MARKETING - NEW METERS** 

1-855-249-7734

1-800-722-0256

**TELEPHONE** 

(908) 412-6169

UNION, NJ 07083

(732) 602-744

6000 HADLEY ROAD

COVER SHEET **G0.01** 

JRS

# DELIVERY STATION


1800 LOWER ROAD, LINDEN, NJ 07036

ISSUED FOR: PLANNING AND ZONING

DATE: 03/17/2020

DJZ6 - ZONING STATISTICS					
LIGHT INDUSTRIAL ZONE REDEVELOPMENT					
CHAPTER 31 - ZONING					
LINDEN, NEW JERSEY					
ZONING STANDARDS	REQUIRED	EXISTING	PROPOSED	VARIANCE	
MIN. LOT AREA (AC)	0.23 AC	17.99 AC	NO CHANGE	NO NO	
MIN. LOT WIDTH (FT)	100 Ft	1,273 Ft	NO CHANGE		
MIN FRONT YARD SETBACK (FT)	30 FT	±85 FT	NO CHANGE	NO	
MIN. SIDE YARD SETBACK (FT)	1 10 ET I 104 ET		NO CHANGE	NO	
MIN. REAR YARD SETBACK (FT)	25 FT	±35 FT	NO CHANGE	NO	
MAX. IMPERVIOUS COVERAGE (%)		92%	93%	NO	
MAX. BLD. HEIGHT (FT/STORIES) 65 FT 40 Ft		NO CHANGE	NO		
MAX. FLOOR AREA RATIO	50%	29%	NO CHANGE	NO	
MIN. LANDSCAPED OPEN SPACE AMENITY (AC)		1.38 AC	1.23 AC	NO	

PARKING AND LOADING STATISTICS						
LINDEN, NEW JERSEY						
	SECTION 31-27 - PARKING AND LOADING REQUIREMENTS					
REGULATIONS	REQUIRED	EXISTING	PROPOSED	VARIANCE		
PARKING SPACES DIMENSION	9 FT X 18 FT	9 FT X 18 FT	9 FT X 18 FT	NO		
AISLE WIDTH	24 FT	25 FT	28 FT	NO		
PARKING SPACES	DISTRIBUTION CENTER (1 SPACE FOR EVERY TWO (2) EMPLOYEES AT PEAK HOUR OF EMPLOYMENT OR ONE (1) SPACE FOR EVERY ONE THOUSAND (1000) SQUARE FEET OF BUILDING AREA, WHICHVER IS GREATER)  GFA = 311,000 SFT (311,000/1000) = 311 SPACES		656	NO		
ADA PARKING		6	6	NO		
VEHICULAR USE SETBACK			NO CHANGE	NO		
LOADING IN FRONT YARD	X					
LOADING SPACE DIMENSION	X					
LOADING SPACE	Х					

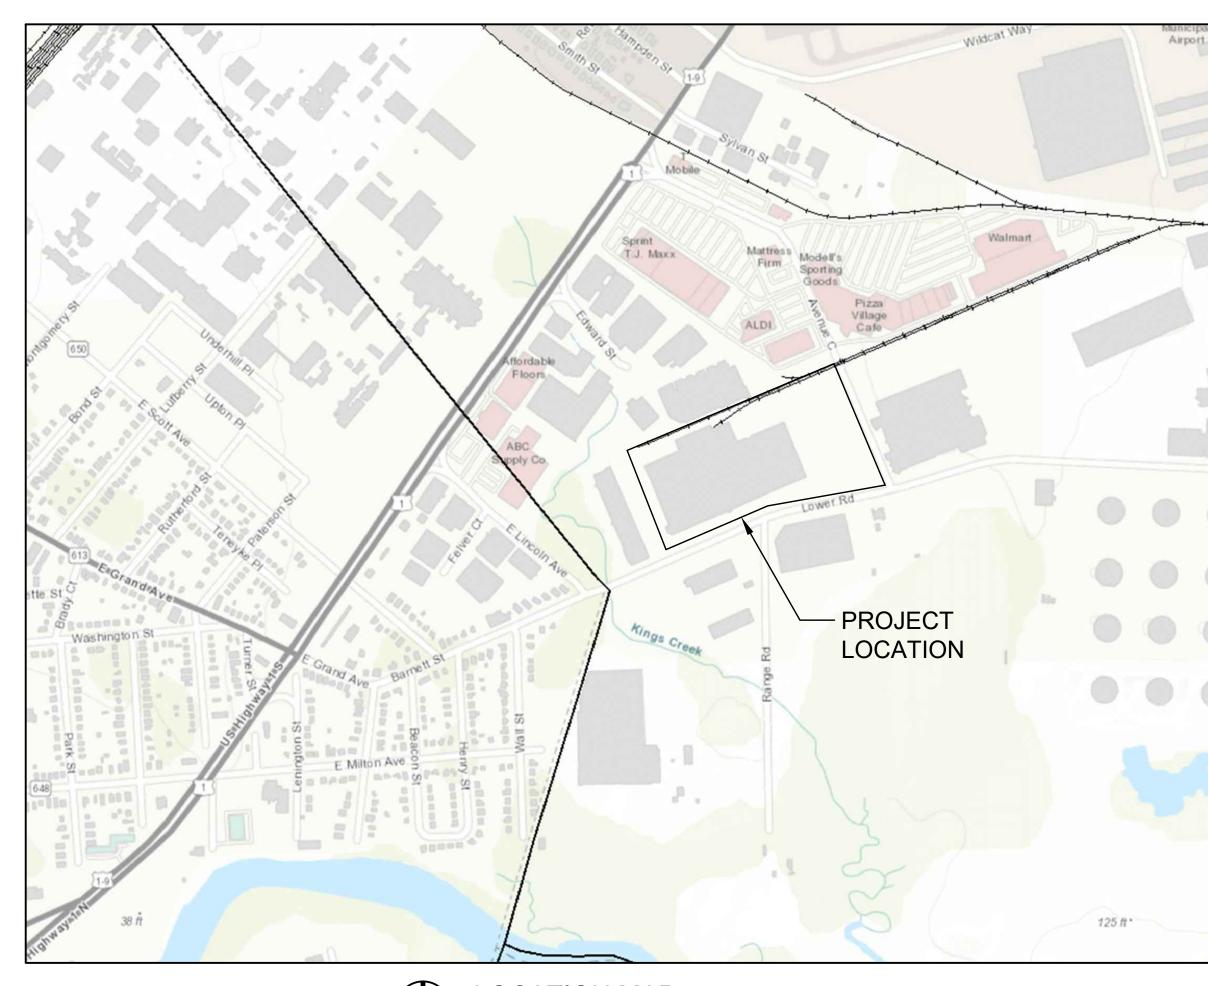

**LOCATION MAP** 

# PROJECT DIRECTORY

OWNER CENTERPOINT LOWER LLC 1808 SWIFT DRIVE OAK BROOK, IL 60523

GRAND RAPIDS, MI 49525 TEL: 616-447-3455

APPLICANT
AMAZON.COM SERVICES LLC

410 TERRY AVENUE NORTH SEATTLE, WA 98109

**ENGINEER** PROGRESSIVE AE ATTN: JOSHUA MANION, PE 1811 4 MILE ROAD NE

progressive ae

# OWNER & ADDRESS REPORT 03/10/20 Page ' 1811 LOWER RD 447,7A,8A

CALL 811 NOTE:


**CONTRACTOR TO CONTACT 811** SERVICE AT LEAST 3 WORKING DAYS PRIOR TO CONSTRUCTION TO CONFIRM LOCATION OF EXISTING UTILITIES. DIAL 811.

# DRAWING INDEX

\*SEE SHEET C2.0 FOR ADJACENT PROPERTY MAP

<ul><li>■ - 03/17/20</li></ul>	G0.01	COVER SHEET
□ □ 03/17/20	C0.0	TOPOGRAPHIC SURVEY
	C1.0	SITE DEMOLITION PLAN
■ - 03/17/20	C1.1	EROSION CONTROL PLAN
■ - 03/17/20	C2.0	OVERALL CONTEXT PLAN
□	C2.1	SITE LAYOUT PLAN
<ul><li>■ - 03/17/20</li></ul>	C2.2	SITE SIGNAGE AND PAVEMENT PLAN
□ □ 03/17/20	C3.0	SITE GRADING AND DRAINAGE
■ - 03/17/20	C4.0	SITE UTILITY PLAN
<ul><li>■ - 03/17/20</li></ul>	C5.0	DETAILS SHEET
<ul><li>■ - 03/17/20</li></ul>	C5.1	SITE SIGNAGE AND GRAPHICS DETAIL SHEET

# DRAWING LIST LEGEND

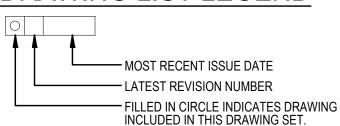

# **CONTACTS & AGENCIES**

CITY OF LINDEN 301 NORTH WOOD AVENUE 3RD FLOOR LINDEN, ROOM 208 NEW JERSEY, 07036 (908) 474-8470

WATER NEW JERSEY AMERICAN WATER 1 WATER STREET CAMDEN, NJ 08102 (866) 777-8426 (NJ OFFICE) 1-800-272-1325 (CUSTOMER SERVICE)

LINDEN ROSELLE SEWERAGE AUTHORITY

5005 SOUTH WOOD AVE P.O. BOX 4118 LINDEN, NJ 07036-8118 (908) 862-7100

ATTN: GARY MARMO 520 GREEN LANE UNION, NJ 07083 (908) 662-8454

NO REMOVAL, DEMOLITION, CLEARING OR TOPSOIL REMOVAL SHALL OCCUR ON SITE UNTIL THE SESC AND STORMWATER PERMITS HAVE BEEN ISSUED AND THE CONTRACTOR HAS VERIFIED AND STAKED THE

NOTIFY SITE CONSULTANT OF THE START OF CONSTRUCTION AND DATE WHEN THE LIMITS LINE WILL BE ESTABLISHED FOR REVIEW AND

ALL MATERIALS NOTED TO BE SALVAGED SHALL BE TURNED OVER TO

THE OWNER OR REINSTALLED ON SITE AS NOTED.

LIMITS OF REMOVAL IN THE FIELD.

BITUMINOUS PAVEMENT

MILL BITUMINOUS PAVEMENT

CONCRETE REMOVAL

EXISTING CONCRETE

ABANDON UTILITY LINE

TREE PROTECTION FENCE


TO REMAIN

TREE REMOVAL

REMOVE CURB

REMOVAL

SITE DEMOLITION PLAN

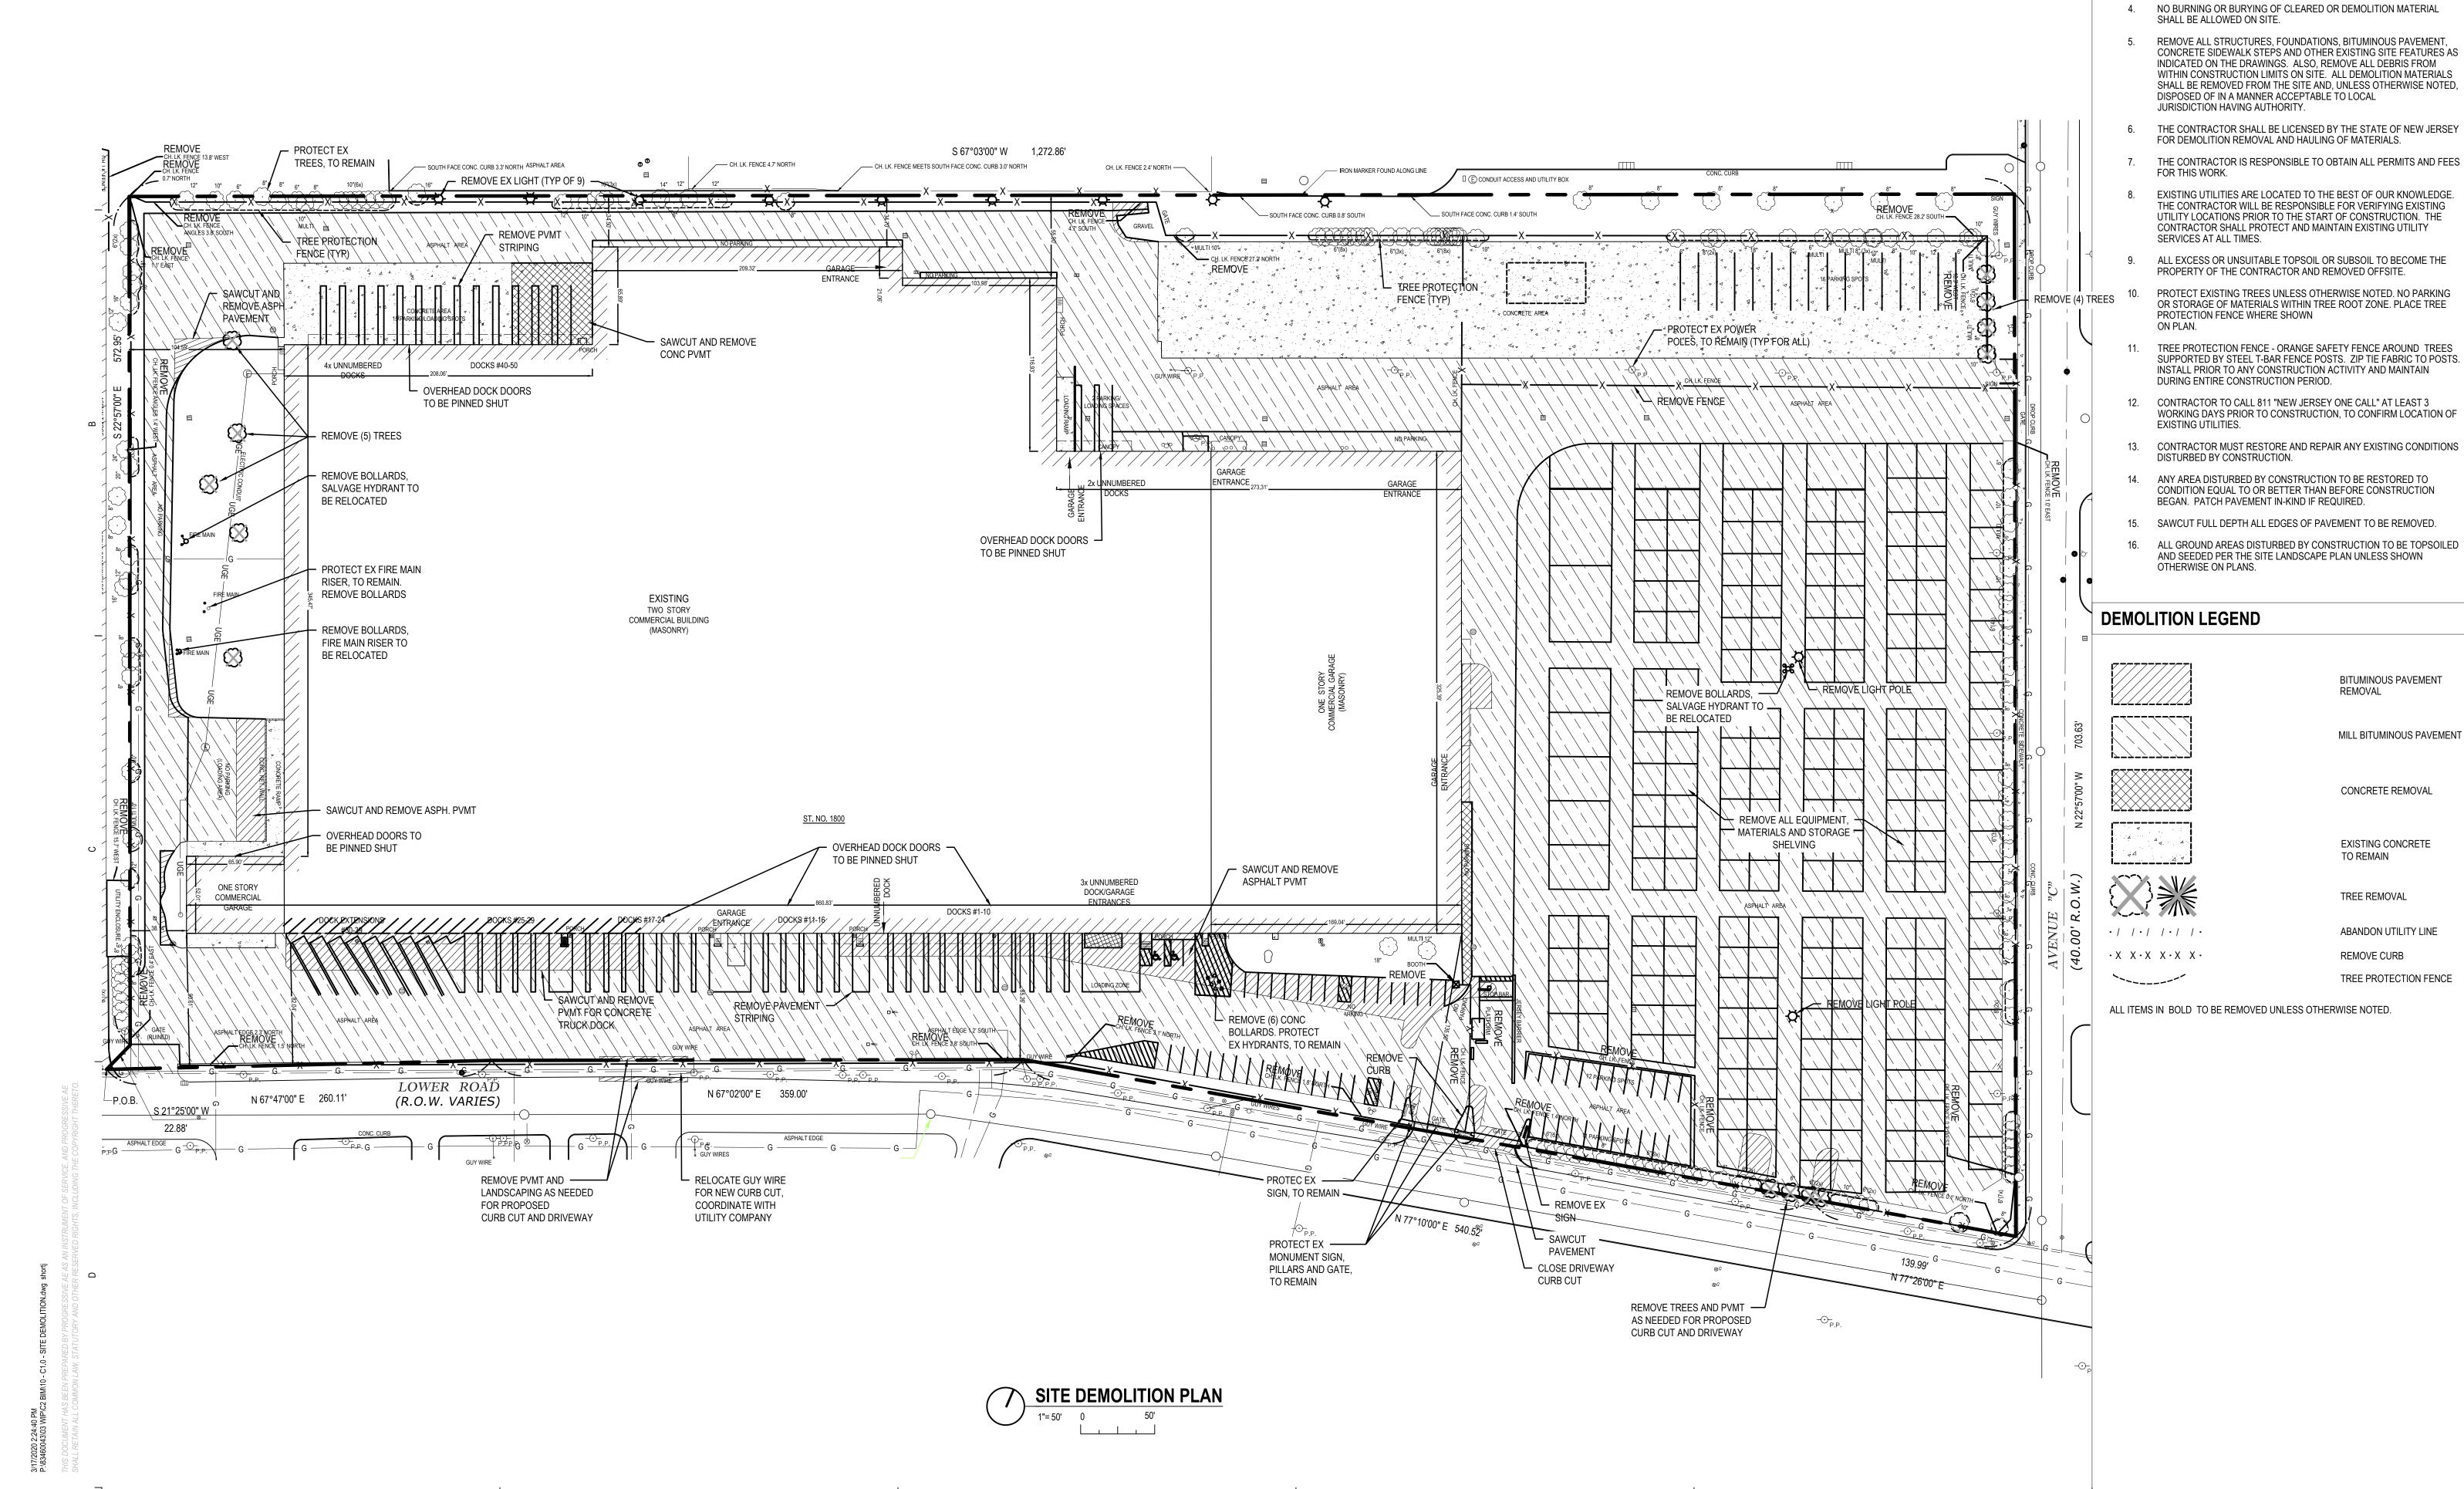

CALL 811 NOTE:

DIAL 811 OR 1.800.272.1000

Know what's below.

Call before you dig.

CONTRACTOR TO CONTACT 811 "NEW JERSEY ONE CALL" SERVICE AT LEAST 3 WORKING DAYS PRIOR

TO CONSTRUCTION, TO CONFIRM

LOCATION OF EXISTING UTILITIES.

INSTALL EROSION CONTROL MEASURES AT THE LIMITS OF EARTHWORK PRIOR TO THE START OF ANY EARTHWORK OPERATIONS. ALL OTHER EROSION CONTROL MEASURES SHALL BE INSTALLED IN CONJUNCTION WITH THE CONSTRUCTION SCHEDULE AND SEQUENCE SHALL BE INSTALLED IN STRICT ACCORDANCE WITH THE PLANS AND

2. MAINTAIN ALL EROSION CONTROL INSTALLATIONS DURING THE COURSE OF CONSTRUCTION. MAKE INSPECTIONS AFTER EACH STORM EVENT AND REPAIR OR REPLACE ANY DAMAGE. REMOVE ACCUMULATED SEDIMENT FROM SEDIMENT BASINS TO MAINTAIN EFFECTIVENESS OF EROSION CONTROL INSTALLATIONS. REPAIR ANY ERODED AREAS ON SLOPES OR NEAR SILT FENCE. REGRADE AND RESEED ANY TEMPORARY SEEDED AREAS AS NECESSARY TO PREVENT EROSION.

THE EROSION CONTROL MEASURES MUST BE INSTALLED AND MAINTAINED IN ACCORDANCE WITH "THE STANDARDS FOR SOIL EROSION AND SEDIMENT CONTROL IN NEW JERSEY".

KEEP PUBLIC ROADWAYS CLEAR OF ACCUMULATED SEDIMENT. SEDIMENTS SHALL BE REMOVED IMMEDIATELY UPON ENTERING PUBLIC ROADWAYS AND SHALL BE RETURNED TO THE LIKELY POINT OF ORIGIN. SEDIMENTS SHALL NOT BE FLUSHED OR WASHED FROM THE AREA WITH WATER.

. SILTSACK MANUFACTURED BY CSI GEOTURF OR HANES GEO PRODUCTS OR APPROVED EQUAL SHALL BE USED FOR STORM INLET PROTECTION ITEM S58 (SEE SESC KEYING SYSTEM LEGEND).

CONTRACTOR SHALL INSTALL AND MAINTAIN SILT FENCE AROUND ALL SUBSOIL SPOIL AND TOPSOIL STOCKPILE AREAS. ALL SOIL PILES SHALL BE SEEDED WITH APPROVED SEED MIXTURES AND BE LOCATED AWAY FROM ANY DOWNSLOPE STREET, DRIVEWAY, DITCH OR DRAINAGE WAY

REMOVE TEMPORARY CONTROL MEASURES AS FOLLOWS:

PAVEMENT AREAS - MAINTAIN IN SERVICE UNTIL PREPARATION FOR PLACEMENT OF BITUMINOUS LEVELING COURSES

LAWN AREAS - REMOVE AFTER LAWN IS WELL ESTABLISHED AND ROOTED

8. SILT FENCE SHALL BE INSPECTED AND REPAIRED ONCE A WEEK AND AFTER EVERY RAIN. SEDIMENT SHALL BE REMOVED IF DEPOSITS REACH HALF THE FENCE HEIGHT.

9. CONTRACTOR WILL BE RESPONSIBLE FOR ALL TEMPORARY SOIL EROSION. OWNER WILL BE RESPONSIBLE FOR PERMANENT SOIL EROSION CONTROL.

10. DUST CONTROL SHALL BE PROVIDED BY MEANS OF WATER DISTRIBUTION ON A

REGULAR BASIS OVER AREAS THAT COULD POTENTIALLY PRODUCE DUST CONDITIONS.

11. CONTRACTOR TO PROVIDE NAME AND NUMBER OF CERTIFIED STORMWATER OPERATOR ASSIGNED TO THIS PROJECT SITE.

# S-E-S-C KEYING SYSTEM

KEY BEST MANAGEMENT PRACTICES SYMBOL

PS PERMANENT SEEDING

Stabilization method utilized on sites where earth change has been completed (final grading attained).

Use adjacent to critical areas, to prevent sediment laden sheet flow from entering these areas.

IP INLET PROTECTION FABRIC DROP

Use at stormwater inlets, especially at construction sites.


# LIMITS OF DISTURBANCE

N 77°26'00" E

TOTAL DISTURBED AREA = 0.92 ACRES

ELIVERTY STA

WHERE USED

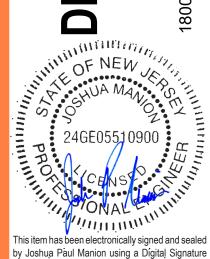

and date. Printed copies of this document are not considered signed and sealed and the signature must be verified on any electronic copies.

s document is sealed and signed in a digital ectronic format and is received from someone than the sealing professional identified in

e document, you must contact the sealing ofessional in writing to validate authenticity of e document. The sealing professional disclaie e seal and signature and shall not be liable for a liability associated with it where the uthenticity of any digital or electronic seal or gnature has not been validated in this manner.

PLANNING AND ZONING 03/17/2020

REVISIONS

**ISSUANCE** 

NO. DATE DESCRIPTION


FILE NUMBER 83
PROJECT MANAGER
PROFESSIONAL
DRAWN BY
CHECKED BY

CION

EROSION
CONTROL PLAN
C1 1

PROFESSIONAL DRAWN BY CHECKED BY

OVERALL CONTEXT PLAN C2.0

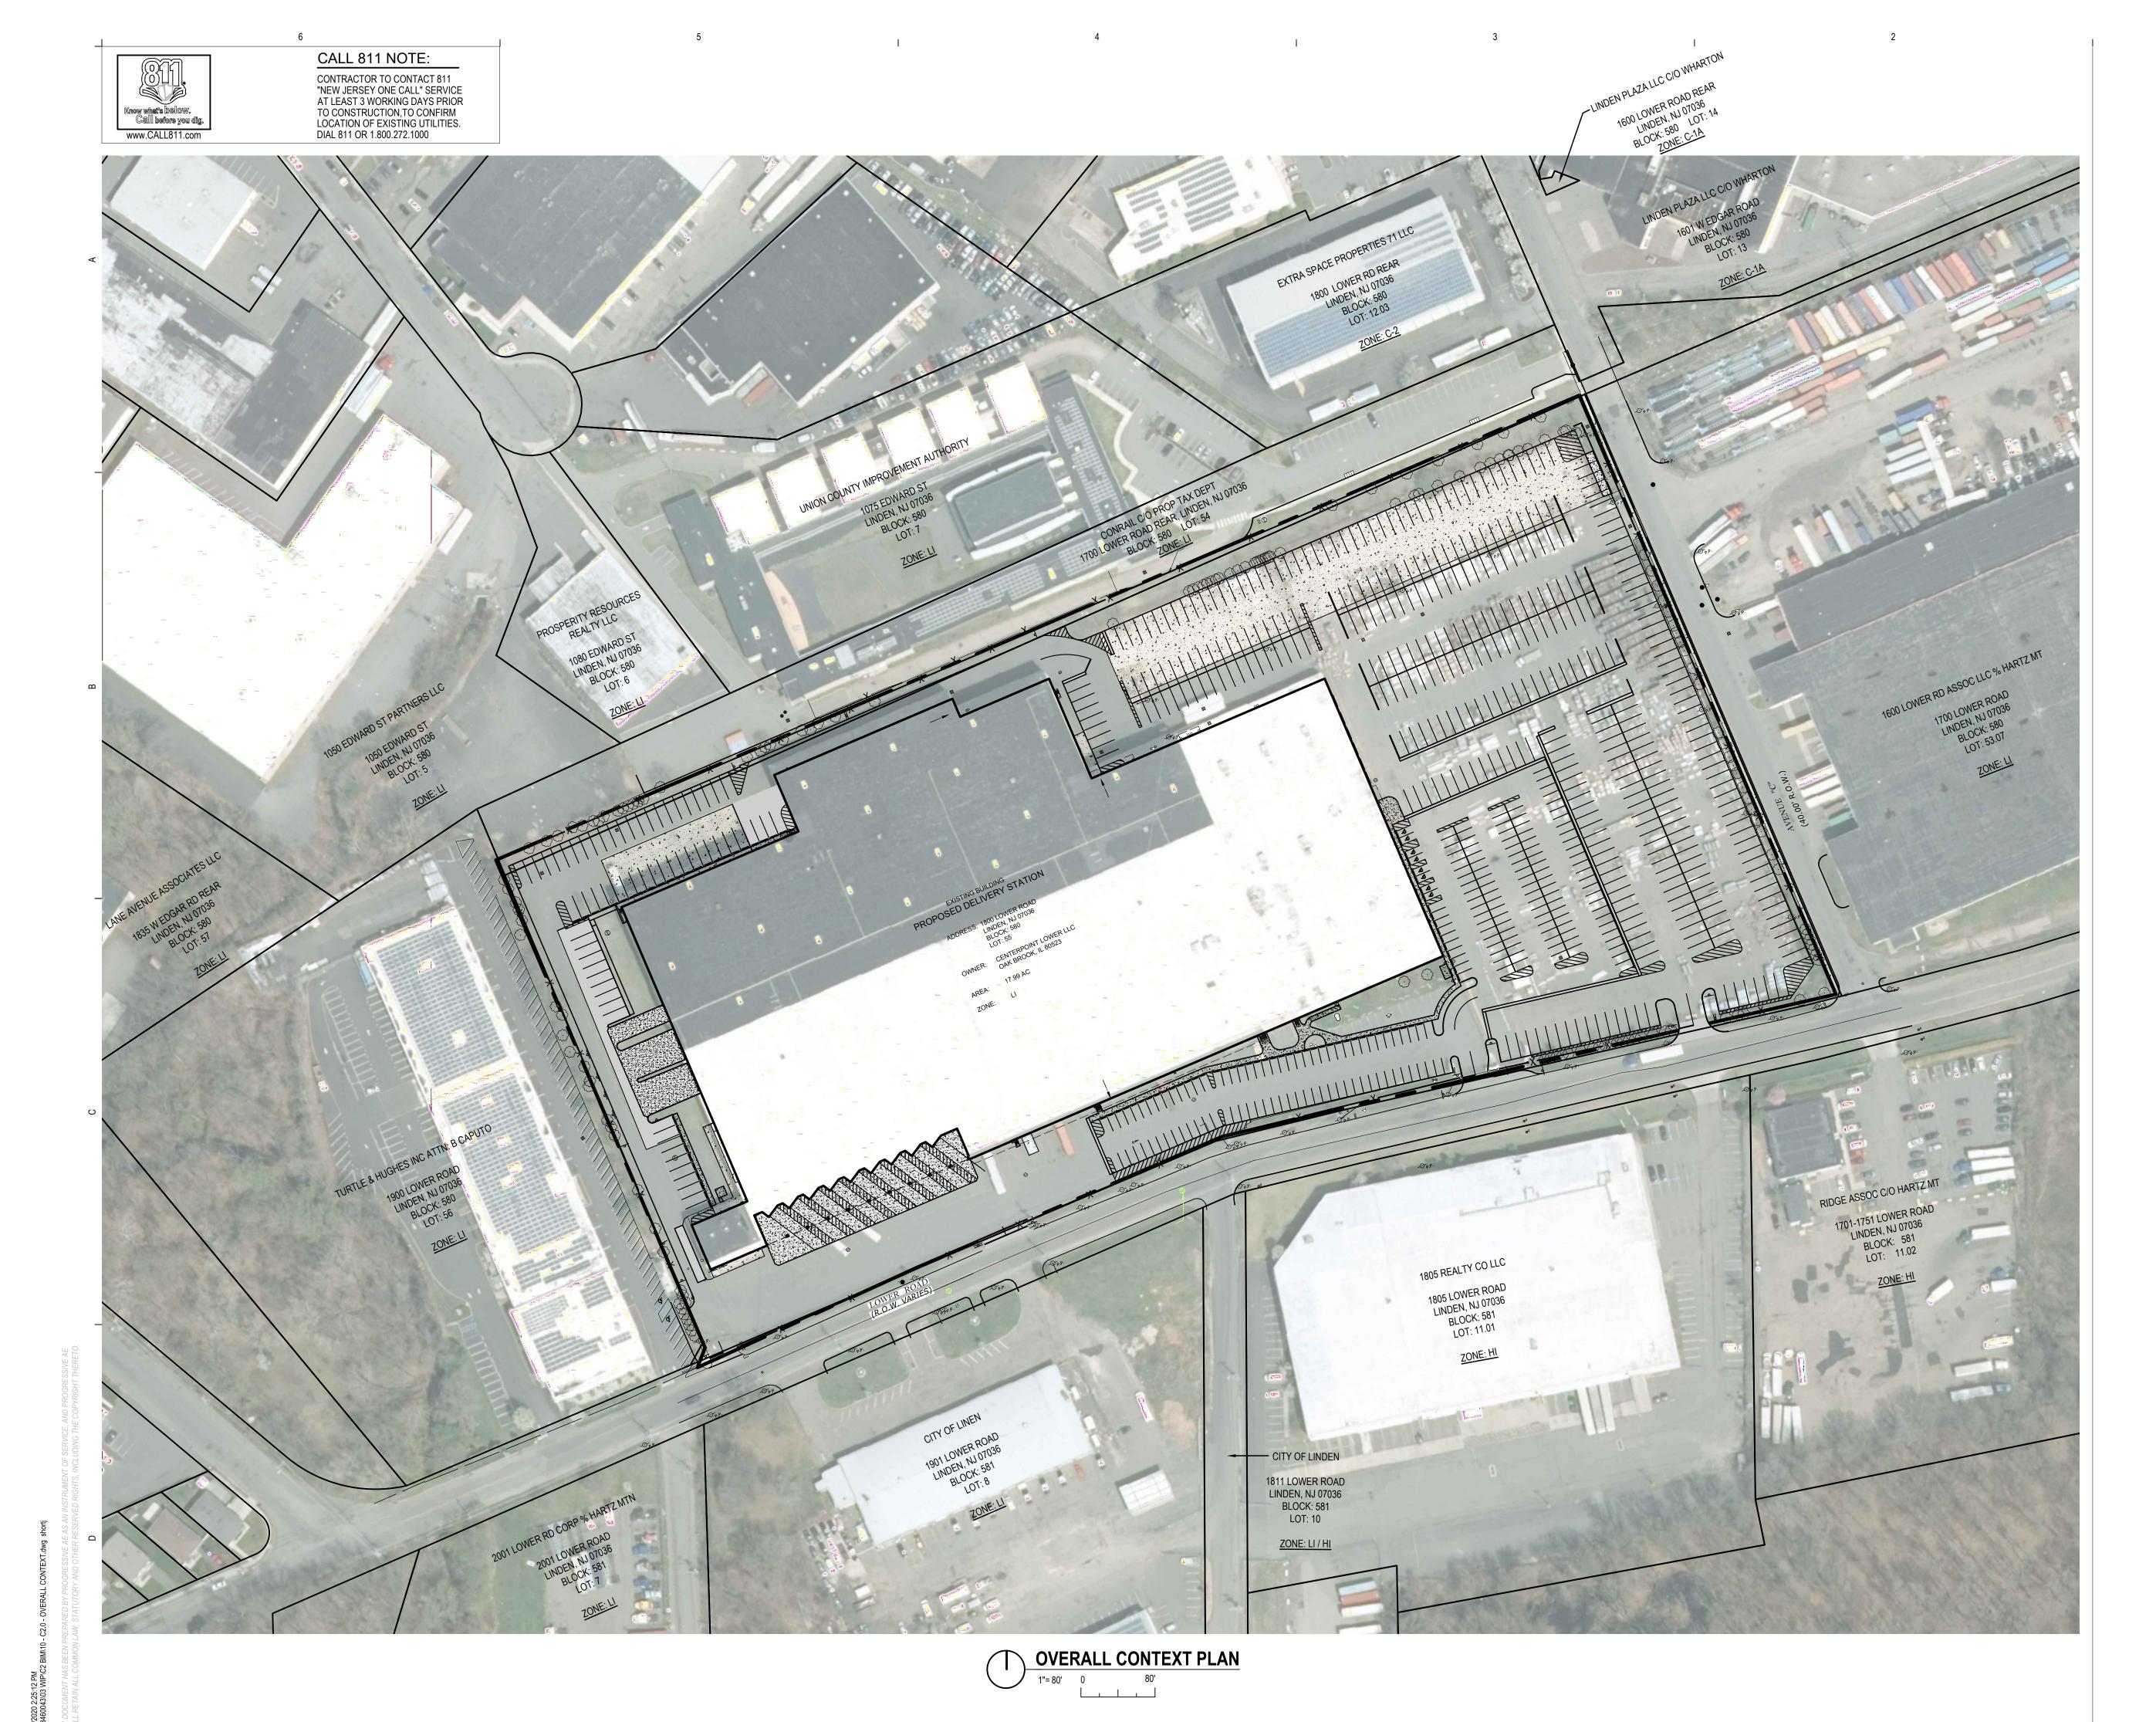

JRV


JPM

JRS

PROJECT MANAGER **PROFESSIONAL** 

DRAWN BY CHECKED BY

SITE LAYOUT PLAN

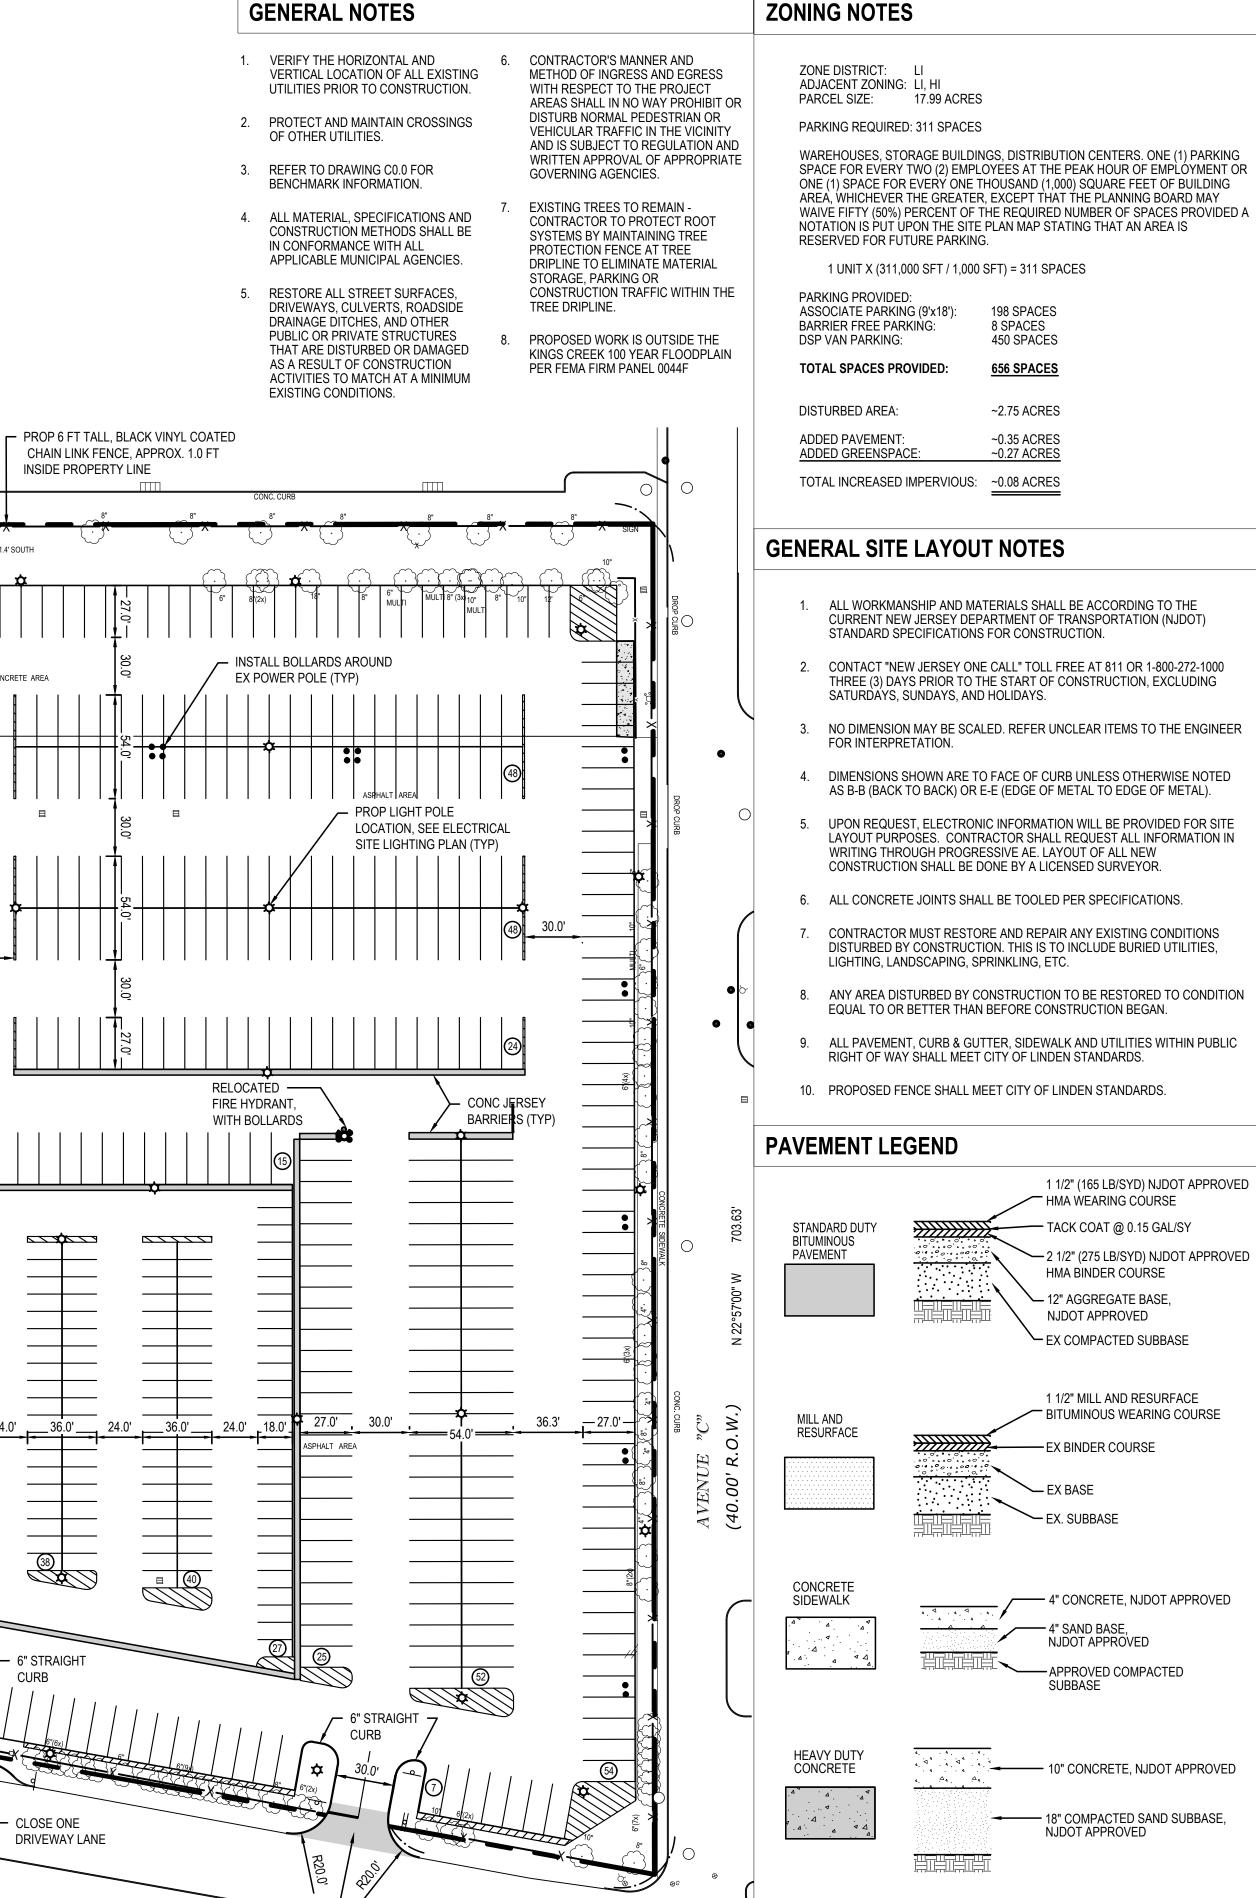

139<sub>.</sub>99'

N 77°26'00" E

STORMWATER SUMMARY NOTES

PROPOSED SITE CALCULATIONS:

DISTURBANCE AREA:

1 ACRE MINIMUM OF DISTURBANCE OR 0.25 ACRE OF IMPERVIOUS INCREASE

IMPERVIOUS INCREASE: 0.14 AC

IMPROVEMENTS ARE PROPOSED.

NJDEP STORMWATER MANAGEMENT RULE APPLICABILITY THRESHOLD:

\*NOTE: THRESHOLDS FOR STORMWATER MANAGEMENT IMPROVEMENTS

ARE NOT MET. NO STORMWATER SYSTEM MODIFICATIONS OR

SITE LAYOUT PLAN

S 67°03'00" W 1.272.86'

CH. LK. FENCE 2.4' NORTH -

GRAVEL

- PROP FLUSH CONC

SIDEWALK

----- IRON MARKER FOUND ALONG LINE

BARRIER FREE -PARKING SPACES

6' CONC PARKING

BUMPER (TYP)

PROP. FLUSH -

CONC SIDEWALK

(3) RIDE SHARE -

WITH SIGNAGE

PROP BOLLARDS

**HYDRANTS** 

TO PROTECT EX FIRE

**EX PILLAR** 

EX GATE

EX MONUMENT —

SIGN WITH NEW SIGN FACE

PARKING SPACES

15'x8' CONC PAD —

N 77°10'00" E 540.52°

% FOR RIDE SHARE

CONCRETE AREA

40.0'

- CLOSE ONE

DRIVEWAY LANE

PROPOSED -

DRIVEWAY CURB CUT

— CH. LK. FENCE MEETS SOUTH FACE CONC. CURB 3.0' NORTH

EXISTING BUILDING

ADDRESS: 1800 LOWER ROAD

LOT: 55

17.99 AC

ZONE:

N 67°02'00" E 359.00'

BLOCK: 580

LINDEN, NJ 07036

OWNER: CENTERPOINT LOWER LLC

OAK BROOK, IL 60523

6' CONC PARKING

BUMPER (TYP)

PROPOSED DELIVERY STATION

EX RAMP TO

PROPOSED VAN PARKING

CALL 811 NOTE:

TO CONFIRM LOCATION OF

EXISTING UTILITIES. DIAL 811.

PROP WALL MOUNTED

LIGHTING PLAN (TYP)

VAN PARKING EXIT RAMP

FIRE HYDRANT AND BOLLARDS

— INTEGRAL CURB

AND WALK

─ 6" STRAIGHT

- RELOCATED

DSP VANS DISPACH RAMP

EX FIRE MAIN RISER,

- RELOCATED

(3) PROPOSED BOLLARDS

FIREMAIN RISER AND BOLLARDS

DSP VANS DISPACH RAMP

- FLUSH CONC SIDEWALK

FOR SMOKING SHELTER

LOWER ROAD

(R.O.W. VARIES)

- 8' CONC PARKING

BUMPER (TYP)

LIGHT, SEE ELECTRICAL SITE

Know what's below.

Call before you dig.

5.0' WALK

5.0' WALK

30.0' . 27.0'

\ S 21°25'00" W

22.88'

ASPHALT EDGE 2.3' NORTH

N 67°47'00" E 260.11'

-42.48'—

www.CALL811.com

CONTRACTOR TO CONTACT 811 SERVICE AT LEAST 3 WORKING

DAYS PRIOR TO CONSTRUCTION,

SOUTH FACE CONC. CURB 3.3' NORTH ASPHALT AREA

 $\,\,\,\,\,\,\,\,$  8' conc parking  $\,\,\,\,\,$ 


BUMPER (TYP) RE-STRIPE

PVMT MARKINGS

PROPOSED

CANOPY

BOLLARDS

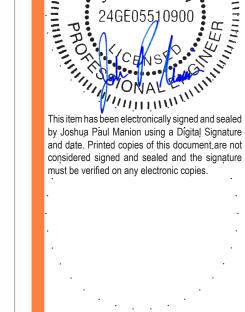

FNEW

liability associated with it where the enticity of any digital or electronic seal o ature has not been validated in this manne

ISSUANCE PLANNING AND ZONING

03/17/2020


REVISIONS

NO. DATE DESCRIPTION

FILE NUMBER PROJECT MANAGER PROFESSIONAL

JRS DRAWN BY CHECKED BY

SITE SIGNAGE AND PAVEMENT

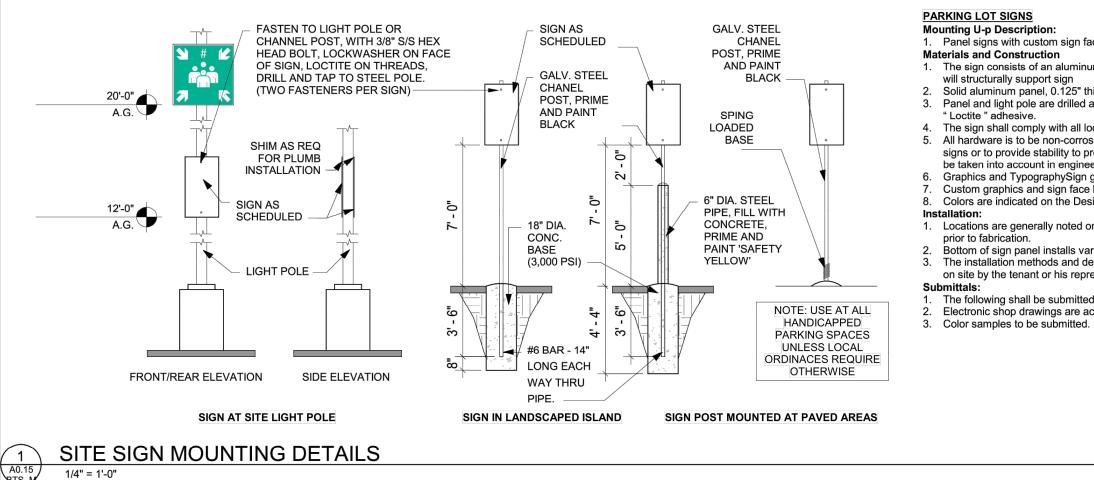

— SOUTH FACE CONC. CURB 3.3' NORTH ASPHALT AREA

SEE DETAIL, THIS SHEET

LOWER ROAD

(R.O.W. VARIES)

AS-13 ——

SEE DETAIL,

○THIS SHEET

PG-1 -

SEE DETAIL,

THIS SHEET

PG-10 →

## PARKING LOT SIGNS Mounting U-p Description 1. Panel signs with custom sign faces

**←** PG-5 (TYP)

**EXISTING BUILDING** 

PROPOSED DELIVERY STATION

ADDRESS: 1800 LOWER ROAD

LOT: 55

AREA: 17.99 AC

ZONE:

LINDEN, NJ 07036 BLOCK: 580

OWNER: CENTERPOINT LOWER LLC OAK BROOK, IL 60523

Materials and Construction . The sign consists of an aluminum sign panel directly attached to an existing light pole. G.C. to verify w/light pole manufacturer that pole

Solid aluminum panel, 0.125" thick. Composite materials are not acceptable. Panel and light pole are drilled and tapped. Panel attaches with two 3/8" hex head bolts, assisted with lock washers and an application of

The sign shall comply with all local codes. Supports shall be sufficient for secure mounting of the sign. All hardware is to be non-corrosive. If additional thickness of material or additional internal bracing is required for secure installation of the signs or to provide stability to prevent warping such alterations shall be reflected in the shop drawings. Wind loading and durability shall

Graphics and TypographySign graphics are heavy duty 3M vinyl. Custom graphics and sign face layouts are available from the owner as electronic files. Colors are indicated on the Design Intent Drawings. Additional color and finish specifications are found in the General Specifications. 1. Locations are generally noted on the attached location plans. The contractor is responsible for field verifying all installation conditions prior to fabrication.

Bottom of sign panel installs varies. The installation methods and details for each location shall be illustrated in the submitted shop drawings. Final locations will be approved on site by the tenant or his representative.

The following shall be submitted for approval prior to fabrication: Electronic shop drawings are acceptable


PG-16


be taken into account in engineering this sign.

1.VERIFY POST SIZE WITH SIGN MOUNTING HEIGHTS. 2.THESE DETAILS PROVIDE INTENT ONLY. FINAL POST &

CONNECTIONS SHALL BE SIZED MEETING LOCAL DOT STANDARDS.

FRONT **BACK** GALV. STEEL CHANEL POST, PRIME AND PAINT BLACK

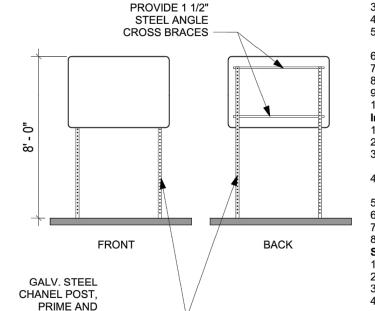

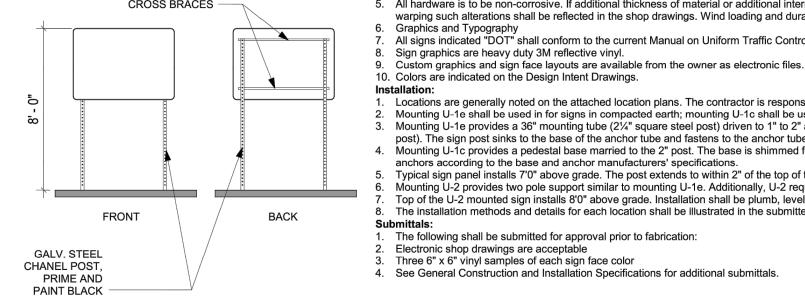

PG-16 ——

40.0'

PG-10 **¬**′

PG-16 —

PG-5 (TYP) ---

\_\_\_\_36.0'\_\_\_\_\_\_24.0' .

36.0'\_\_\_

Electronic shop drawings are acceptable Three 6" x 6" vinyl samples of each sign face color 4. See General Construction and Installation Specifications for additional submittals.

30.0'

PG-16

Mounting U-1e, U-1c, U-2

Post: 2" square steel post, 12 ga, 7/16" perforations on 1" centers, four sides, approx 12' o/a

1. Post and panel signs with standard sized DOT and custom sign faces

The sign consists of an aluminum sign panel on a 2" square steel post

anchors according to the base and anchor manufacturers' specifications.

Post and Panel Signs

Materials and Construction:

SPECIFICATIONS: SEE WORLDWIDE REAL ESTATE SIGNAGE STANDARDS (REV. 10) FOR COLOR GENERAL NOTES AND ADDITIONAL SIGNAGE

CUSTOM CUT VINYL GRAPHICS, ATTACHED TO FIRST

SURFACE OF EXTERIOR GLASS.

**GRAPHICS AND TYPOGRAPHY:** SIGN GRAPHICS ARE HEAVY DUTY '3M' VINYL. LOGO IS A HIGH RESOLUTION DIGITAL PRINT ON PERMANENT ADHESIVE PRESSURE SENSITIVE VINYL SUBSTRATE WITH LUSTER OVER LAMINATE, CUT TO SHAPE FROM VECTOR FILE. COPY IS MATTE WHITE VINYL.

INSTALLATION:

LOCATIONS ARE GENERALLY NOTED ON THE ATTACHED LOCATION PLANS. THE CONTRACTOR IS RESPONSIBLE FOR FIELD VERIFYING ALL INSTALLATION CONDITIONS PRIOR TO FABRICATION. THE INSTALLATION METHODS AND DETAILS FOR EACH LOCATION SHALL BE ILLUSTRATED IN THE SUBMITTED SHOP DRAWINGS. FINAL LOCATION WILL BE APPROVED ON SITE BY THE TENANT REPRESENTATIVE.

SUBMITTALS:

THE FOLLOWING SHALL BE SUBMITTED FOR APPROVAL PRIOR TO FABRICATION - (3) SETS OF SHOP DRAWINGS AND (3) 6" X6" VINYL SAMPLES OF ÉACH SIGN FACE COLOR. SEE GENÉRAL CONSTRUCTION AND INSTALLATION SPECIFICATIONS FOR ADDITIONAL SUBMITTALS.

# SIGNAGE GENERAL NOTES

. FINAL QUANTITIES SHALL BE COORDINATED AND VERIFIED IN FIELD. 2. ADDITIONAL SIGNAGE NOT SHOWN ON GRAPHICS PLAN MAY BE REQUIRED PER LOCAL CODE AND/OR AHJ. SUB-CONTRACTOR SHALL COORDINATE WITH LOCAL AHJ AND PROVIDE AS REQUIRED. . MOUNT SIGNAGE ACCORDING TO LOCAL CODES.

BRAILLE CHARACTERS PER ANSI 117.1-2003 TYPICAL SIGN FONT IS SET IN AERIAL.

SITE SIGNAGE AND PAVEMENT MARKINGS

SEE DETAIL, ▼ THIS SHEET

4" WHITE STRIPING

11'x27' DSP VAN

PARKING SPACE

(TYP.)

G-5<u>(TYP)</u>

42.48'

27.0'

"TRUCKS

ASPHALT EDGE 2.3' NORTH

(2) AS-6

4" WHITE STRIPING -9'x18' ASSOCIATE

 $\bigcirc$ 

PARKING SPACE

(TYP.)

PG-8 -

**EXISTING** 

MONUMENT

AS-32 -

SEE DETAIL,

THIS SHEET

- AS-32

SEE DETAIL,

THIS SHEET

SEE DETAIL, THIS SHEET

- AS-33 (2)

4. ALL PERMANENT SIGNAGE TO ACCESSIBLE AREAS TO HAVE RAISED

6. SEE DOOR SCHEDULE FOR DOOR SIGNAGE REQUIRED TEXT.

MARKINGS

MATCH EX. RIM ELEV=13.8±

GR. 13.78 INV. 9.8

RIM ELEV = 15.95

SIDEWALK RAMP

VAN PARKING EXIT

> DSP VAN DISPATCH RAMPS

MATCH EX.

LOWER ROAD

(Ŕ.O.W. VARIĖS)

SAN. M.H. RIM 14.44

Φ GR. 15.67 INV. 12.4

► FLUSH CONC SIDEWALK

PROP 2' DIA

RIM = 15.908" IE (SE) = 14.00

NYLOPLAST CATCH BASIN

☐ MATCH EX ROAD

GRADE AT DRIVE

21 LF OF 8" SDR-35 PVC

STORM PIPE AT 1.0% MIN SLOPE

EXISTING BUILDING

ADDRESS: 1800 LOWER ROAD

LOT: 55

ZONE:

BLOCK: 580

LINDEN, NJ 07036

OWNER: CENTERPOINT LOWER LLC

OAK BROOK, IL 60523

SAN. M.H. RIM 16.43 INV. (RIM SEALED)

PROPOSED DELIVERY STATION

2. 2% MAXIMUM CROSS SLOPE ON ACCESSIBLE ROUTE(S)

6. CONTRACTOR TO CONTACT ENGINEER PRIOR TO PAVING IF BARRIER

GR. 16.39 INV. 13.3

CONDUIT ACCESS AND UTILITY BOX

47367

PARKING SPACES

RIM. 17.08 4' INV. 8.7

FLUSH CONCRETE -

SIDEWALK, ENSURE 2% MAX CROSS SLOPE

FLUSH CONCRETE

MATCH EX -

ROAD GRADE

AT DRIVE

SIDEWALK

EARTHWORK AND PAVEMENT CONSTRUCTION ARE TO BE PERFORMED IN ACCORDANCE WITH THE NJDOT STANDARD SPECIFICATIONS FOR

THE SUBGRADE SHALL BE THOROUGHLY PROOFROLLED USING THE EQUIVALENT OF A FULLY LOADED TANDEM AXLE TRUCK HAVING A MINIMUM AXLE WEIGHT OF 10 TONS. SOFT OR YIELDING AREAS THAT CANNOT BE MECHANICALLY STABILIZED SHOULD BE REMOVED AND REPLACED WITH

GEOTECHNICAL/PAVEMENT ENGINEER.

FINISHED SUBGRADE SURFACE SHALL NOT BE MORE THAN 0.1 FEET ABOVE OR BELOW ESTABLISHED FINISHED SUBGRADE ELEVATIONS AND ALL GROUND SURFACES SHALL VARY UNIFORMLY BETWEEN INDICATED ELEVATIONS. FINISHED DITCHES SHALL BE GRADED TO ALLOW FOR PROPER DRAINAGE WITHOUT PONDING AND IN A MANNER THAT WILL

AT A MINIMUM OF 1.5 PERCENT.

THE PAVED EDGE.

EXISTING SOIL ON SITE MUST BE EVALUATED BY A GEOTECHNICAL

ENGINEERED FILL LOCATED WITHIN PAVEMENT AND BUILDING AREAS CONDITIONED TO WITHIN 2 PERCENT OF OPTIMUM MOISTURE CONTENT. COMPACT TO MINIMUM OF 95 PERCENT OF THE MAXIMUM DRY DENSITY

ALL FILL OPERATIONS SHALL BE OBSERVED BY A QUALIFIED SOIL TECNHICIAN. A MINIMUM OF ONE COMPACTION TEST SHALL BE CONDUCTED PER 2,500 SFT AREA AT EACH LIFT. WITHIN TRENCH EXCAVATIONS, ONE TEST SHALL BE CONDUCTED FOR EACH 100 LINEAR

10. SIDE SLOPES SHALL NOT EXCEED 1 VERTICAL OVER 3 HORIZONTAL SLOPE UNLESS SHOWN OTHERWISE.

11. PARKING LOT CURBS SHALL BE BUILT WITH REVERSE SLOPE ON THE DOWNHILL SIDE OF THE ISLAND TO ASSURE POSITIVE STORM WATER RUNOFF TO CATCH BASINS.

12. UNLESS SHOWN OTHERWISE, FINISH GRADES OF LAWN/LANDSCAPE ADJACENT TO BUILDING WALLS SHALL BE 6" BELOW FINISH FLOOR

13. PLACE 6" MINIMUM TOPSOIL IN ALL LANDSCAPE AREAS TO BE SEEDED. PROVIDE POSITIVE DRAINAGE AT ALL TIMES TO ENSURE NO STANDING WATER WITHIN PAVEMENT, BUILDING PAD, OR GREEN AREAS.

14. FOR ALL CURB ISLANDS, CENTER OF ISLANDS TO BE A MINIMUM OF 6"


15. ADJUST ALL CATCH BASIN AND MANHOLE RIMS TO BE FLUSH WITH PROPOSED SURFACE OF PAVEMENT.

# **GRADING LEGEND**

FLOW ARROW TOP OF PAVEMENT TOP OF CURB TOP OF WALL **BOTTOM OF WALL** GROUND **GUTTER PAN** FINISH FLOOR ELEVATION EXISTING ELEVATION HIGH POINT LOW POINT LANDING

NOTE: SITE GRADING TO MATCH EXISTING DRAINAGE

SLOPE EACH DIRECTION

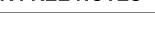

WITH THE AMERICANS WITH DISABILITIES ACT, INCLUDING BUT NOT

3. 5% MAXIMUM LONGITUDINAL SLOPE (DIRECTION OF TRAVEL) UNLESS AT BARRIER FREE RAMP

4. 2% MAXIMUM SLOPE LONGITUDINAL AND TRANSVERSE SLOPES AT BARRIER FREE PARKING SPACES AND ASSOCIATED ACCESS AISLES

5. ACCESSIBLE ENTRIES - 2% MAXIMUM SLOPE IN ANY DIRECTION FOR THE FIRST 5' FROM ENTRY DOOR

FREE SLOPES DO NOT COMPLY OR FOR CLARIFICATION OF ANY DISCREPANCIES.

# **EARTHWORK & GRADING NOTES**

CONSTRUCTION UNLESS OTHERWISE NOTED IN THE FOLLOWING ITEMS.

ENGINEERED FILL.

PROOFROLLING SHALL BE PERFORMED UNDER THE OBSERVATION OF A

GRADE THE AGGREGATE BASE MATERIAL TO PROVIDE POSITIVE DRAINAGE

THE AGGREGATE BASE AND SUBBASE SHALL EXTEND 12 INCHES BEYOND

ENGINEER FOR USE AS FILL. ANY IMPORTED SOILS USED FOR ENGINEERED FILL SHALL BE EVALUATED BY A GEOTECHNICAL ENGINEER PRIOR TO

SHALL BE PLACED IN 8 INCH MAXIMUM LOOSE THICKNESS AND MOISTURE PER ASTM D-1557, MODIFIED PROCTOR METHOD

HIGHER THAN TOP OF CURB.

INV.(E) 12.7 INV.(S) 14.9 Q

5' TURNING RADIUS, 2% MAX

PATTERNS UNLESS OTHERWISE NOTED.

SITE GRADING AND DRAINAGE PLAN

SITE GRADING AND DRAINAGE PLAN

03/17/2020

DRAWN BY

CHECKED BY

OF NEW

by Joshua Paul Manion using a Digital Signature

and date. Printed copies of this document are not

considered signed and sealed and the signature


must be verified on any electronic copies.

CALL 811 NOTE:

CONTRACTOR TO CONTACT 811
SERVICE AT LEAST 3 WORKING
DAYS PRIOR TO CONSTRUCTION,
TO CONFIRM LOCATION OF
EXISTING UTILITIES. DIAL 811.

## **UTILITY NOTES**

- FIELD LOCATE EX WATERMAIN LOCATION ON SITE PRIOR TO START OF CONSTRUCTION. NOTIFY ENGINEER OF ANY UTILITY CONFLICTS.
- 2. INSTALL WATERMAIN WITH MINIMUM 5.0' OF COVER TO TOP OF PIPE.
- 3. PROVIDE A MINIMUM 18" OF VERTICAL SEPARATION AND 10' OF HORIZONTAL SEPARATION BETWEEN WATERMAIN AND ALL SANITARY AND STORM SEWERS.
- 4. PROVIDE APPROVED MECHANICAL RESTRAINED JOINTS AT ALL WATERMAIN BENDS FOR A MINIMUM DISTANCE FROM THE FITTING AS SHOWN IN THE PIPE RESTRANT TABLE.
- 5. WATERMAIN MATERIAL AND INSTALLATION SHALL BE PERFORMED IN ACCORDANCE WITH CITY OF LINDEN SPECIFICATIONS.
- 6. 4" AND LARGER WATERMAIN PIPE SHALL BE DUCTILE IRON PIPE.
- 7. 2" AND SMALLER DOMESTIC WATER SERVICE SHALL BE TYPE K COPPER

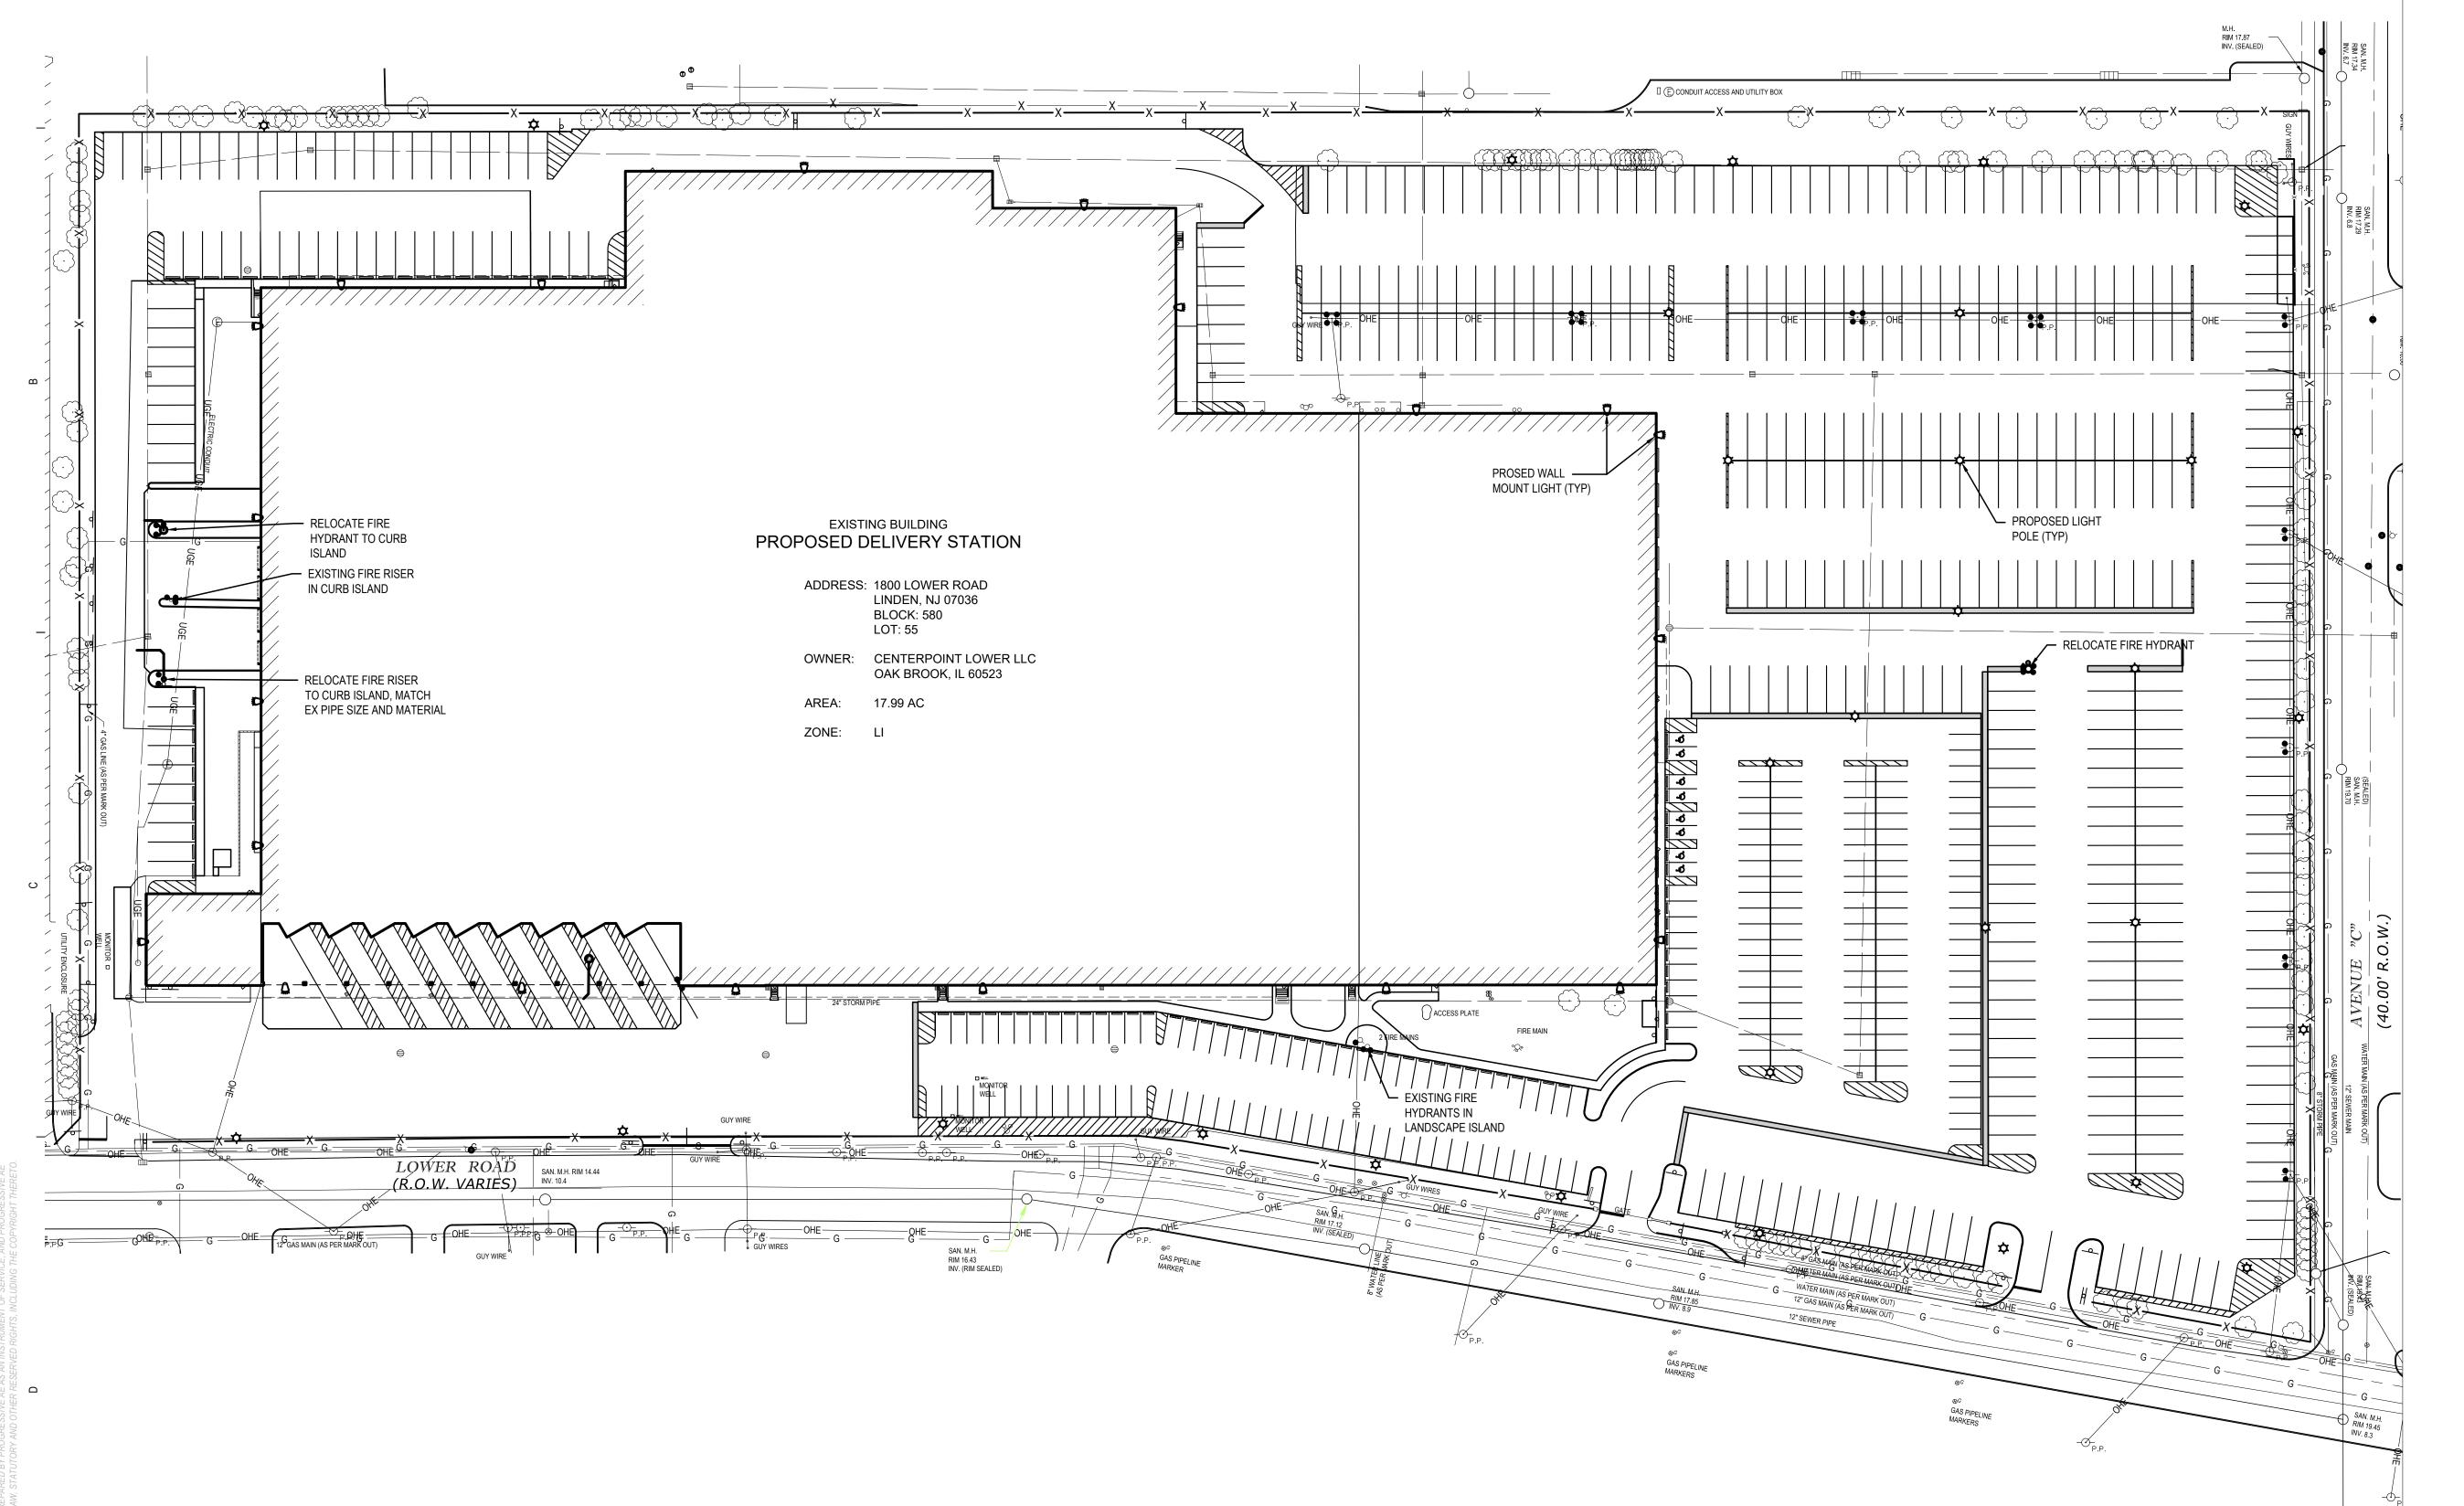

SITE UTILITY PLAN

1"= 50' 0 50'

DE SAUA MANOZ 24GE05510900

This item has been electronically signed and sealed by Joshua Paul Manion using a Digital Signature and date. Printed copies of this document are not considered signed and sealed and the signature must be verified on any electronic copies.

is document is sealed and signed in a digital lectronic format and is received from someone or than the sealing professional identified in document, you must contact the sealing ressional in writing to validate authenticity of document. The sealing professional disclaims seal and signature and shall not be liable for liability associated with it where the nenticity of any digital or electronic seal or liature has not been validated in this manner.

ISSUANCE
PLANNING AND ZONING
03/17/2020

REVISIONS


NO. DATE DESCRIPTION


FILE NUMBER
PROJECT MANAGER
PROFESSIONAL
DRAWN BY
CHECKED BY

JRS JPM

SITE UTILITY PLAN

P:\83460043\03 \WIP\C2 BIM\10 - C4.0 - SITE UTILIT

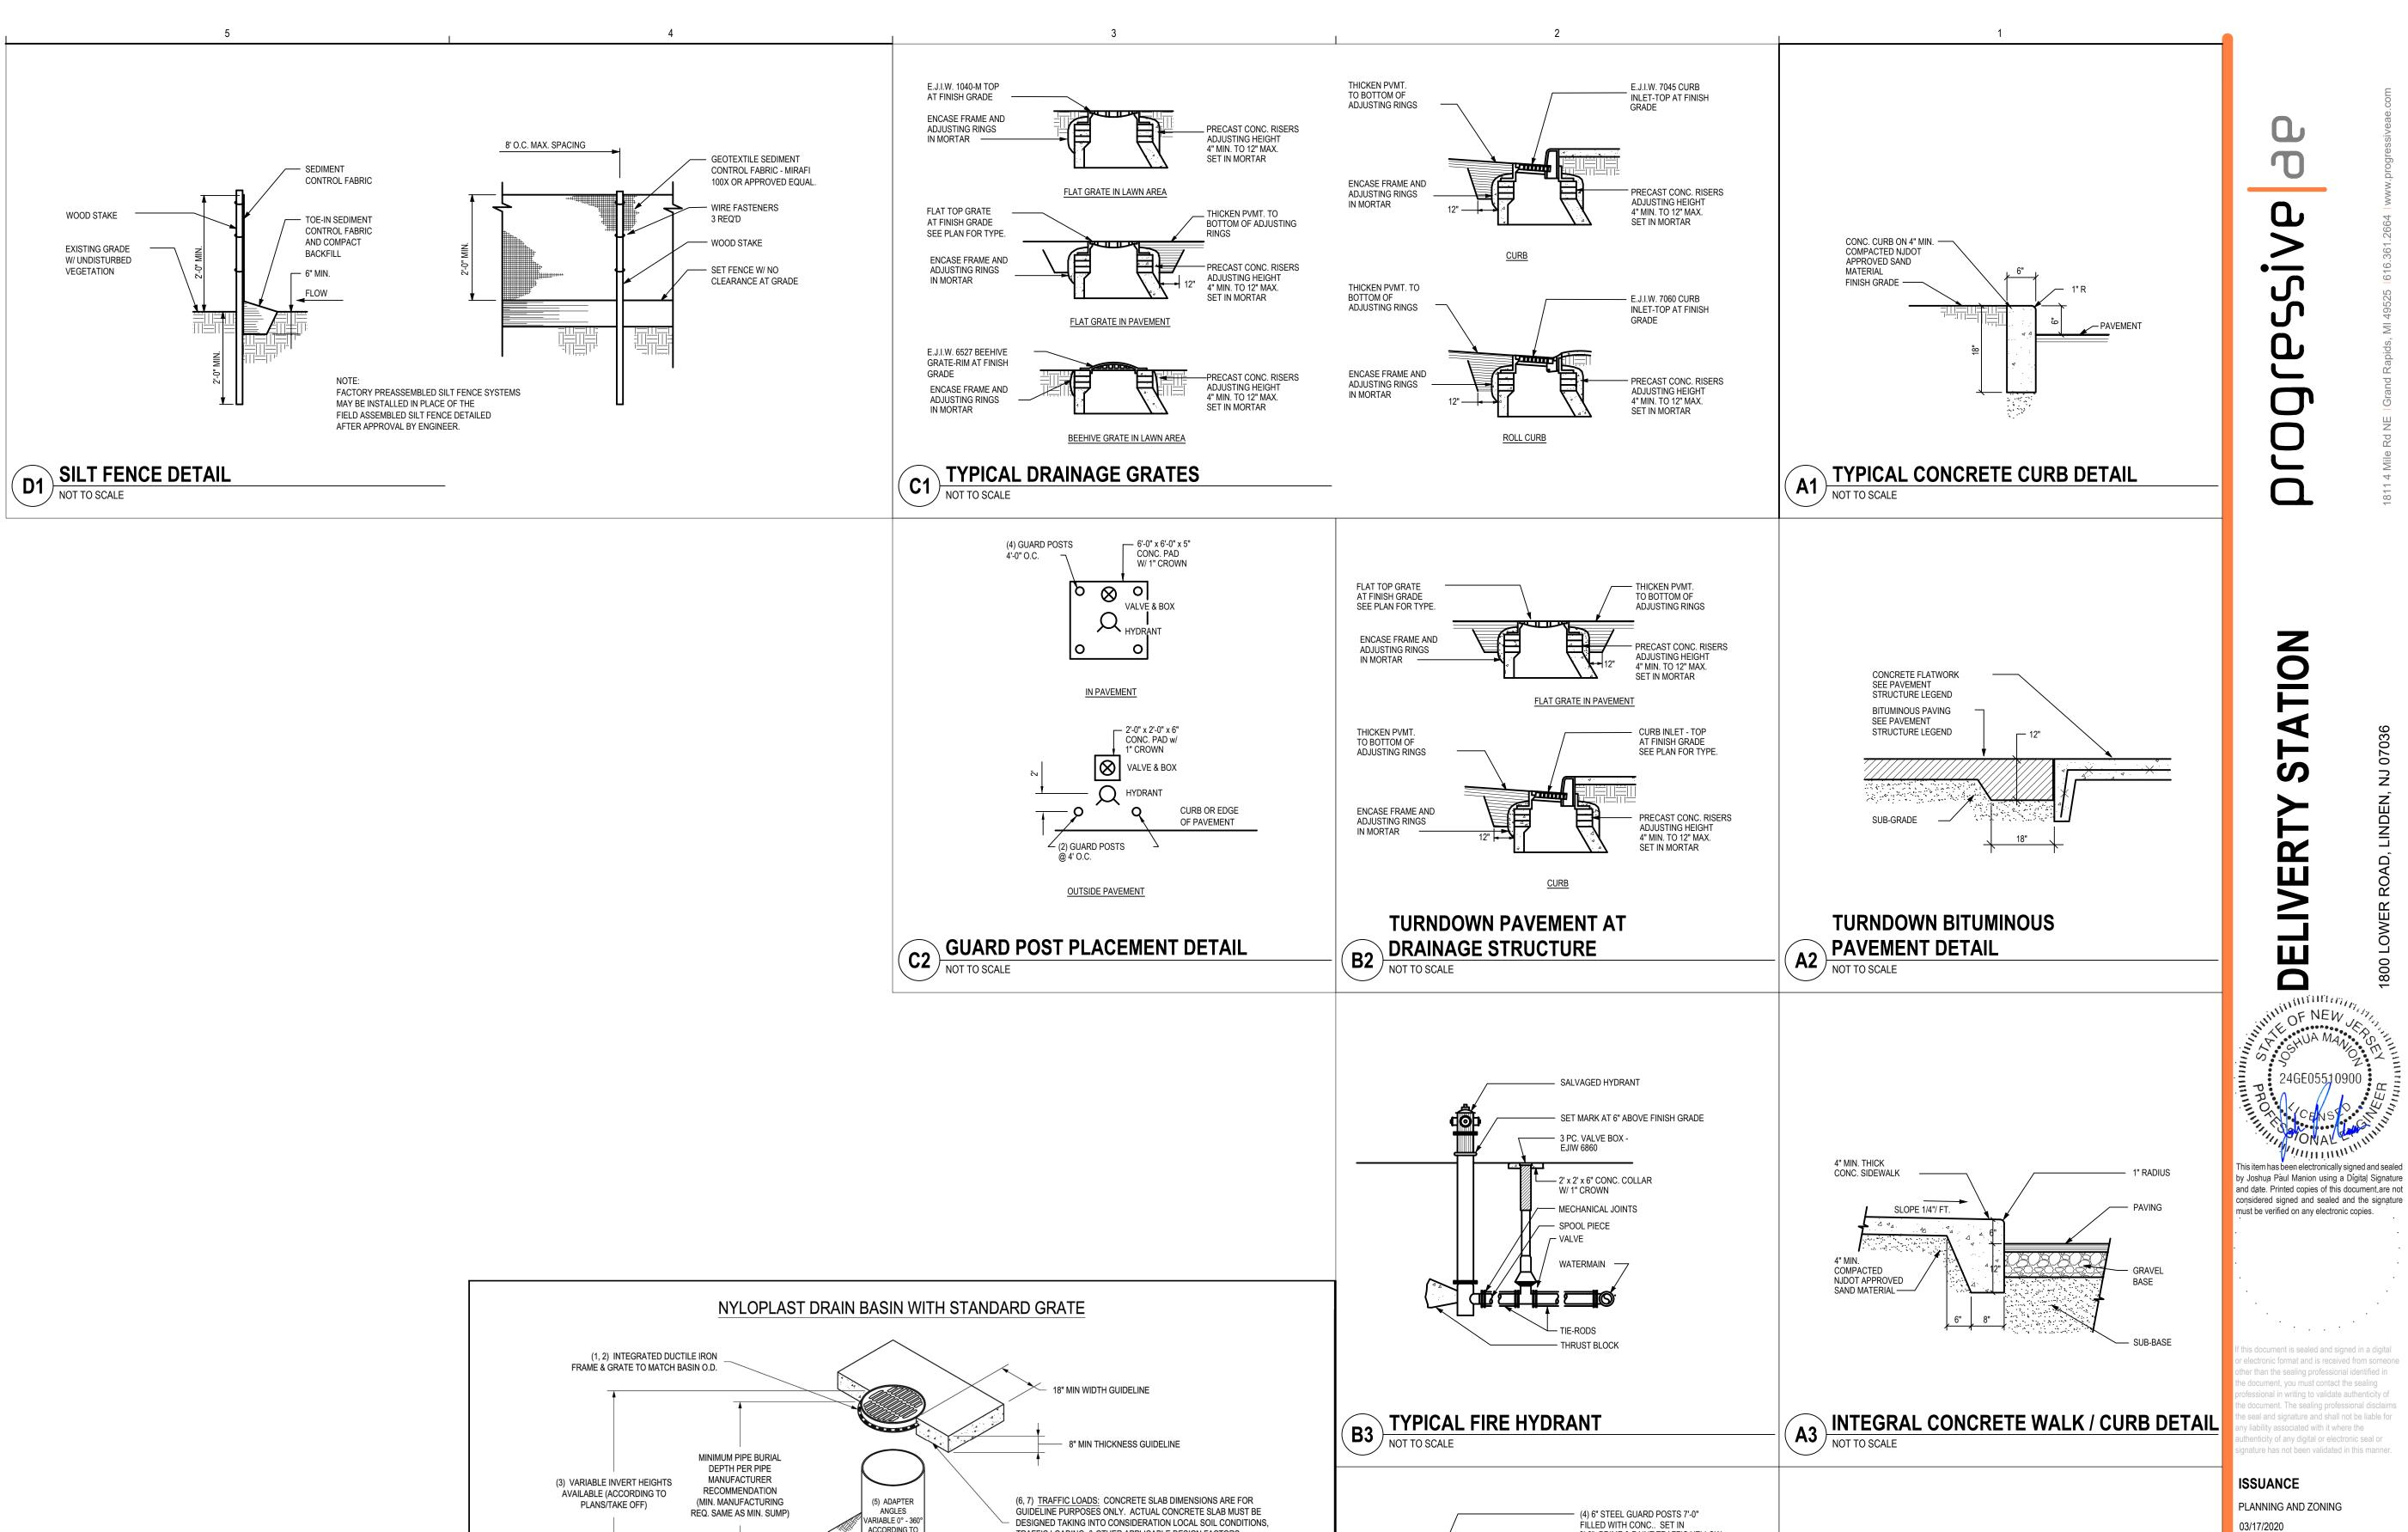

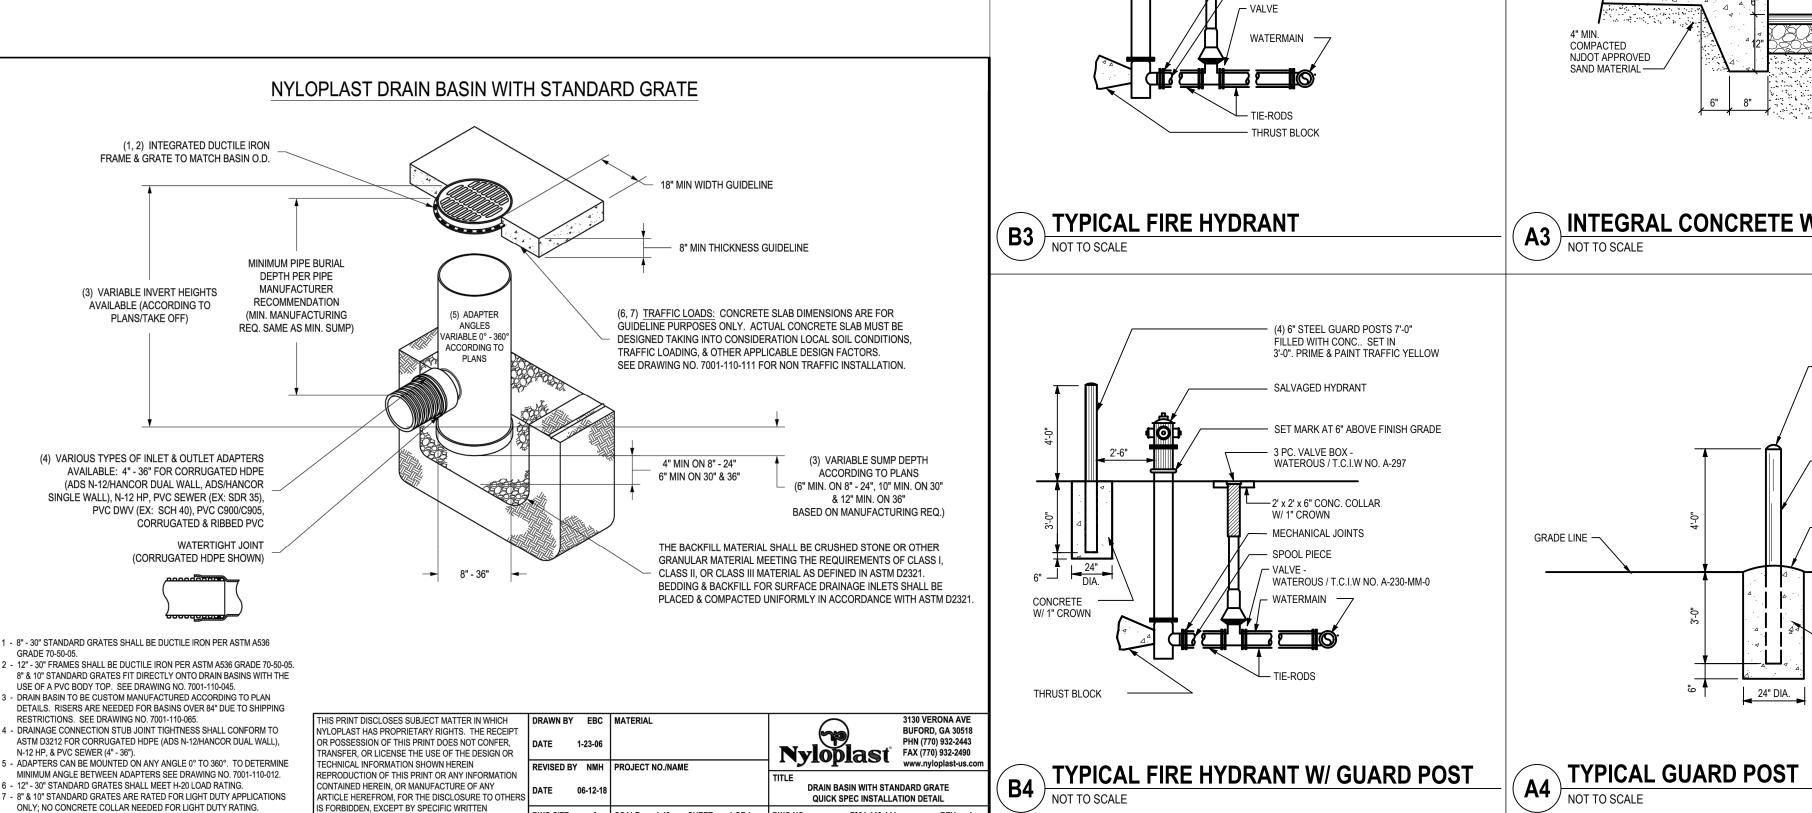

7001-110-144

REV J

DWG SIZE A SCALE 1:40 SHEET 1 OF 1 DWG NO.

- PROVIDE SAFETY YELLOW THERMOPLASTIC BOLLARD COVER BY IDEAL SHIELD NO. DATE DESCRIPTION OR EQUAL. — 6" DIA. STEEL PIPE, PRIMED AND CONC. FILLED. - PROVIDE 1" SLOPE TO FINISH GRADE OR PAVEMENT CONCRETE

PROJECT MANAGER **PROFESSIONAL** DRAWN BY CHECKED BY

**REVISIONS** 

FILE NUMBER

83460043

JRV

JPM

JRS

JPM

DETAILS SHEET C5.0

and date. Printed copies of this document are not

83460043 JRV

JPM


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JPM


FILE NUMBER PROJECT MANAGER PROFESSIONAL DRAWN BY CHECKED BY

SITE SIGNAGE

**AND GRAPHICS** 

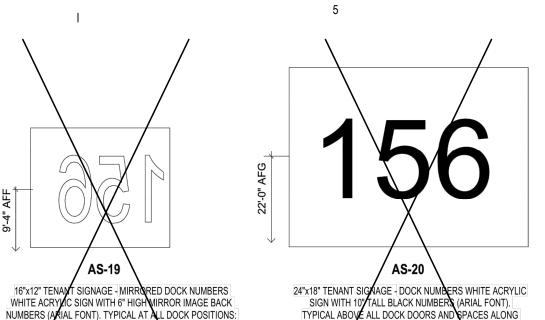

TYPICAL ABOVE ALL DOCK DOORS AND SPACES ALONG FENCE. MOUNTED DIRECTLY TO EXTERIOR BUILDING FACADE, CENTERED ABOVE DOCK DOOR. (SEE BUILDING LAN SHEETS FOR DOOR NUMBER

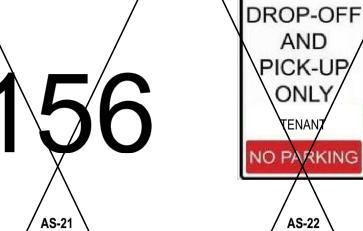

20"x10" TENANT SIGNAGE - DOCK NUMBERS (INTERIOR) 10"


TALL BLACK DIE-CUT VINYL NUMBERS (ARIAL FONT). ÓN

INTERIOR SIDE OF DOOR DOCK, TYPICAL AT ALL DOCK

DOORS. CENTER ON DOOR, MOUNT HORIZONTAL CENTER

TO 9'-0" A.F.F. (SEE BUILDING PLAN SHEETS FOR DOOR

AS-22 24" X 36" TENANT SIGNAGE - STANDING ONLY USE TO DENTIFY DROP OFF/PICK UP ZONES. POST (X2) AND PANEL MOUN BLACK TEXT (ARIAL) ON WHIT BACKGROUND, ORANGE TENAI ARROW GRAPHIC, WHITE "NO PARKING" TEXT ON RED BACKGROUND

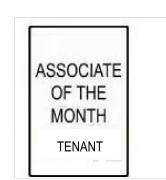

12" X 18" TENANT SIGNAGE - ASSOCIATE OF THE MONTH PROVIDE 4 ASSOCIATE OF THE MONTH PARKING SPACES NEAR THE MAIN ENTRY. POST AND PANEL MOUNT. ONE SIGN PER PARKING SPACE. BLACK TEXT (ARIAL NARROW) ON

WHITE BACKGROUND, ORANGE

TENANT GRAPHIC.



AS-24 12" X 18" TENANT SIGNAGE - CUSTON TENAN**T** SIGNAGE - VENDOR PARKING PARKING ONLY ROVIDE 2 LARGE PARKING PROVIDE MINIMUM 10 SPACES NEAR THE MAIN CUSTOMER PARKING SPACES ENTRY FOR VENDORS. NEAR THE MAIN ENTRY. POST AND PANEL MOUNT. POST AND PANEL MOUNT. ONE SIGN PER PARKING SPACE. ONE SIGN PER PARKING SPACE. BLACK TEXT (ARIAL NARROW) BLACK TEXT (ARIAL NARROW) ON WHITE BACKGROUND, ON WHITE BACKGROUND, ORANGE TENANT ORANGE TENANT GRAPHIC


VENDOR

PARKING


AS-25

12" X 18"

GRAPHIC.

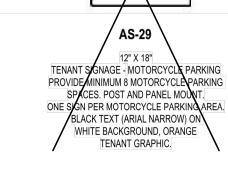



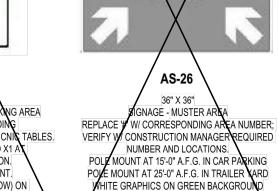



▲ DANGER
DO NOT HOOK ON FLASHING RED LIGHT

DO NOT HOOK ON FLOCHT HOLL SHAPE THOUL SHAP THOUL SHAPE THOUL SHAP

INDICATOR SIGN

PROVIDE SIGN A


SUILDING EXTERIOR A

EACH DOCK DOOR.

SIGN TO BE PROVIDED

AND INSTALLED BY GC

8" TALL CHARACTERS TENANT SIGNAGE - EXTERIOR HOLLOW METAL DOOR NUMBERS BLACK DIE-CUT VINYL CHARACTERS, ARIAL FONT. INSIDE AND OUTSIDE OF ALL EXTERIOR HOLLOW METAL DOORS. CENTER ON DOOR, MOUNT HOR ZONTAL CENTER TO 5'-3" A.F. (SEE BUILDING LAN SHEETS FOR DOOR NUMBERS)

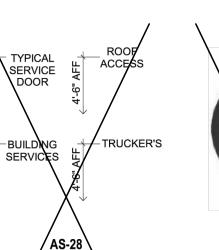


DRIVER'S SIDE OF DOCK DOORS MOUNT DIRECTLY TO

EXTERIOR BUILDING FACADE. (SEE BUILDING PLAN SHEETS

FOR DOOR NUMBERS)

4" TALL CHARACTERS TENANT SIGNAGE - HOLLOW METAL DOOR NUMBERS BLACK DIE-CUT VIN IL CHARACTERS . ARIAL FONT. ON SELECTED HOLLOW NETAL DOORS. CENTER ON DOOR, MOUNT HORIZONTAL CENTER TO 4'-6" A.F.F. (SEE BUY DING PLAN SHEETS FOR DOOR NUMBERS)

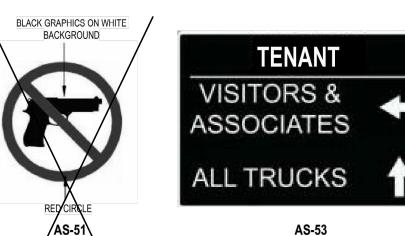

AS-53 TENANT SIGNAGE - SORTATION TENANT SIGNAGE - NO FIREARMS MUS BE POSTED AT ALL EXTERIOR ENTRANCES WAYFINDING USE AT SORTATION SITES AS TO ANY BUILDING WHERE FIREARMS ARE PROMBITED. MUST BE POSTED AT EYE NECESSARY FOR WAYFINDING. LEVEL OF ADULTS (4'-6" AFG). MUST NOT POST AND PANEL MOUNT.

WHITE TEXT (ARIAL) ON BLACK


BACKGROUND.


ADJUST TEXT AND ARROW(S

DIRECTION BASED ON SITE

LOCATION.




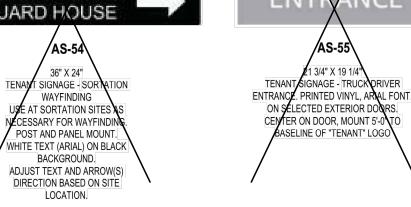


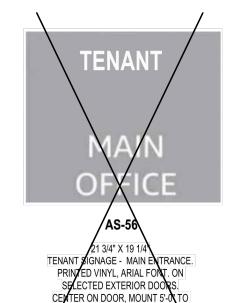

BASELINE OF "TENANT" LOGO



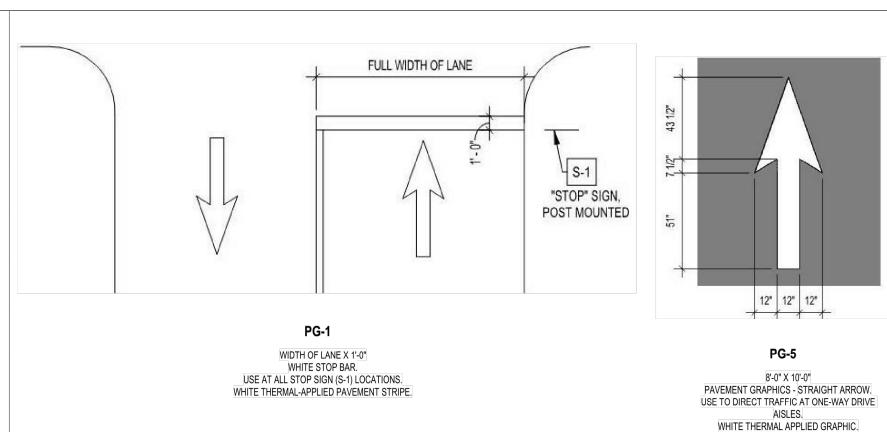

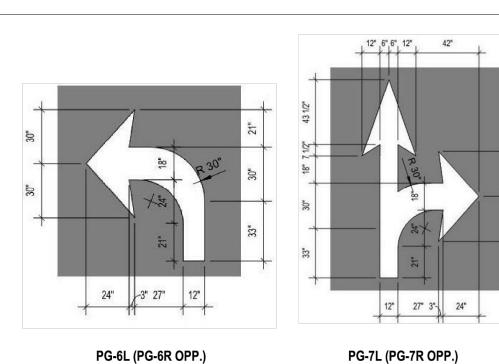

5" TALL CHARACTERS TENANT SIGNAGE WINDOW GLASS


NUMBERS WHITE LETTERING (ARIAL FONT) APPLIED TO

EXTERIOR SIDE OF WINDOW GLASS, CORRESPOND TO

DOOR NUMBER. YPICAL AT ALL GLASS ENTRY DOORS (SEE

BUILDING PLAN SHEETS FOR DOOR NUMBERS)

PG-6L (PG-6R OPP.) 8'-0" X 8'-0" 8'-0" X 8'-0" PAVEMENT GRAPHICS - LEFT TURN ARROW PAVEMENT GRAPHICS - LEFT TURN ARROW. USE TO INDICATE TURNING LANES. USE TO INDICATE TURNING LANES. WHITE THERMAL APPLIED GRAPHIC WHITE THERMAL APPLIED GRAPHIC. (BLACK INDICATES ASPHALT) (BLACK INDICATES ASPHALT)

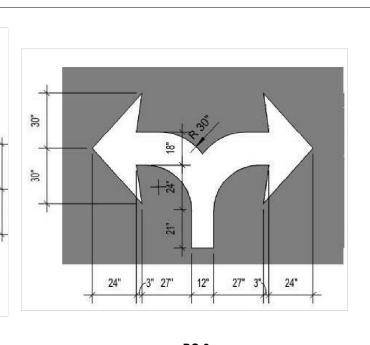


MORE THAN 12" TO THE RIGHT OR LEFT

OF EACH ENTRANCE


PG-8 8'-0" X 8'-0" 10'-0" X 12'-0" PAVEMENT GRAPHICS - LEFT TURN ARROW. PAVEMENT GRAPHICS - LEFT, STRAIGHT, OR RIGHT TURN ARROW. USE TO INDICATE TURNING LANES. USE TO INDICATE TURNING LANES. WHITE THERMAL APPLIED GRAPHIC WHITE THERMAL APPLIED GRAPHIC (BLACK INDICATES ASPHALT) (BLACK INDICATES ASPHALT)

"ADA" BLUE BACKGROUND


WITH WHITE SYMBOL

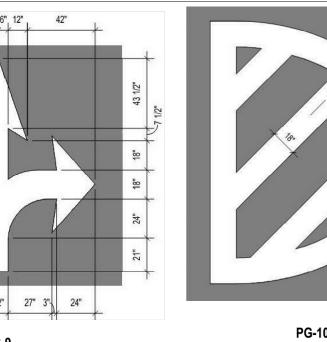


18" STRIPING OUTLINE AND FILL AT 45 DEGREES. PAVEMENT GRAPHICS - TRAFFIC ISLAND. USE TO PROHIBIT VEHICLE TRAVEL AND PARKING. THERMAL APPLIED STRIPES; YELLOW AT NO TRAFFIC, BLUE AT ACCESSIBLE PARKING SPACES, WHITE AT VENDOR PARKING (BLACK INDICATES ASPHALT). INCLUDE AT EMERGENCY EXITS INTO THE PARKING LOT AT ALL PARKING SPACES THAT IMPEDE DIRECT ACCESS TO THE THOROUGHFARE.

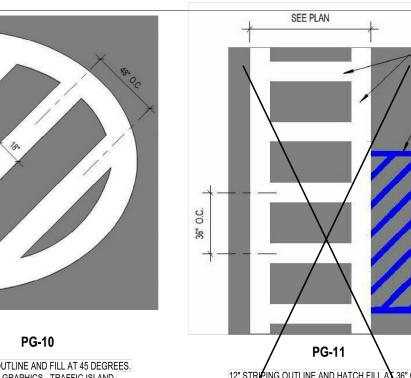


12" STRIPING OUTLINE AND HATCH FILL AT 36" O.C. PAVEMENT GRAPHICS - PEDESTRIAN CROSSWALK. USE TO INDICATE PEDESTRIAN CROSSING THERMAL APPLIED WHITE STRIPES. SEE PLAN FOR WIDTH OF CROSSWALK (BLACK INDICATES ASPHALT)

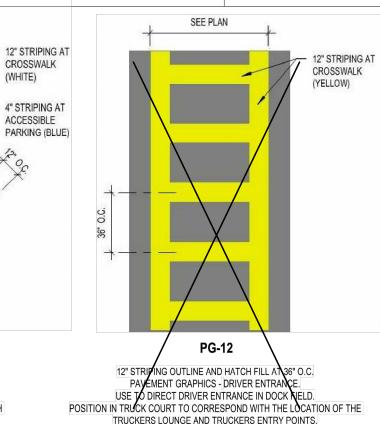


TRUCKERS LOUNGE AND TRUCKERS ENTRY POINTS. THERMAL APPLIED YELLOW STRIPES, SEE PLAN FOR WIDTH OF CROSSWALK (BLACK INDICATES ASPHALT)

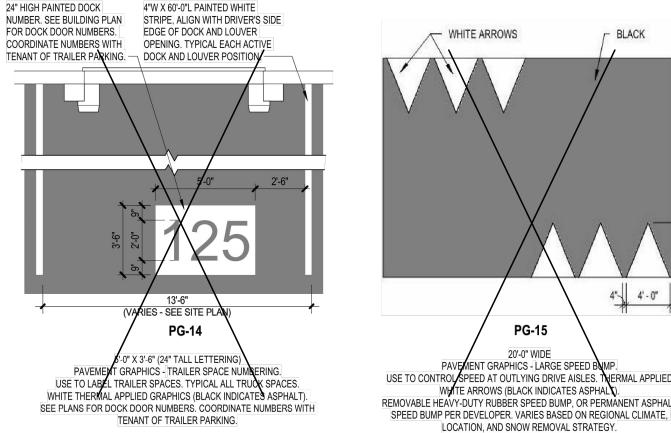

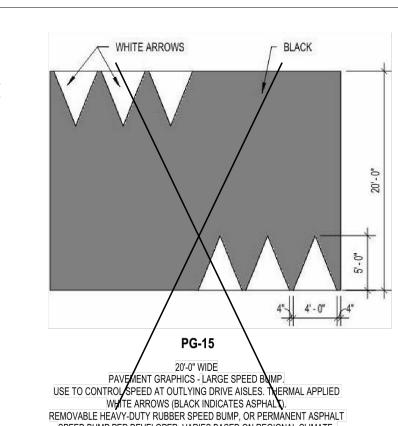



(BLACK INDICATES ASPHALT)

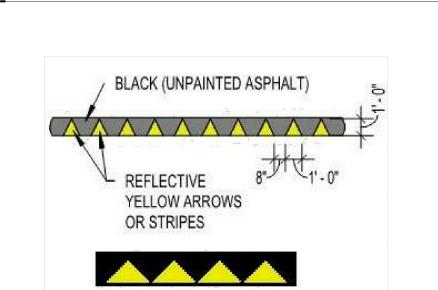


12'-0" X 1'-0" PAVEMENT GRAPHICS - SMALL SPEED BUMP USE TO CONTROL SPEED AT INTERIOR DRIVE AISLES. THERMAL APPLIED REFLECTIVE YELLOW ARROWS. REMOVABLE HEAVY-DUTY RUBBER SPEED BUMP, OR PERMANENT ASPHALT SPEED BUMP PER DEVELOPER. VARIES BASED ON REGIONAL CLIMATE, LOCATION, AND SNOW REMOVAL


STRATEGY.

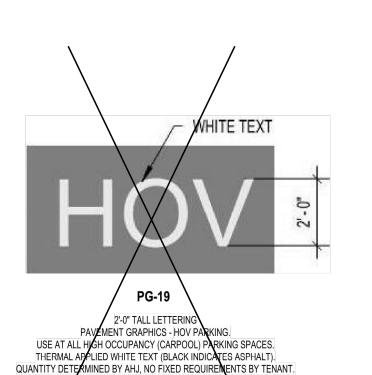


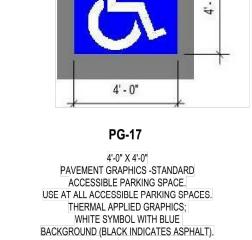





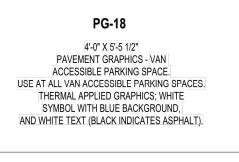

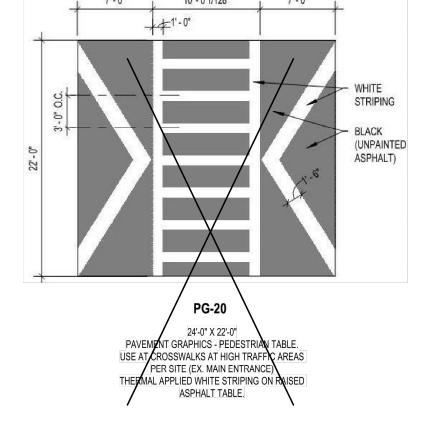


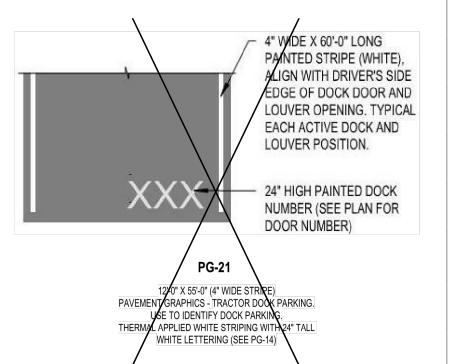

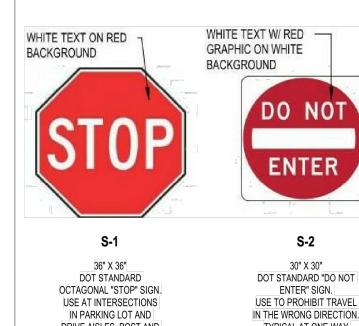

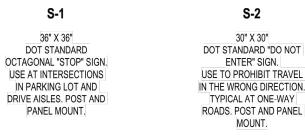





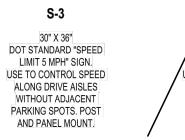


- BLACK TEXT ON WHITE


BACKGROUND

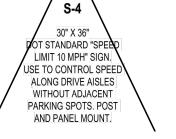


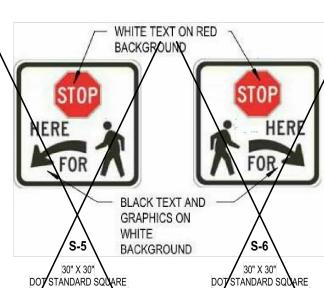


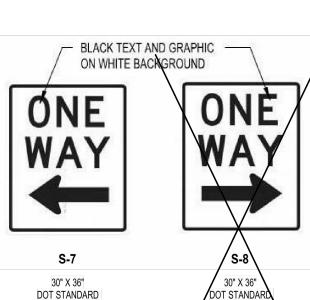



AND PANEL MOUNT.

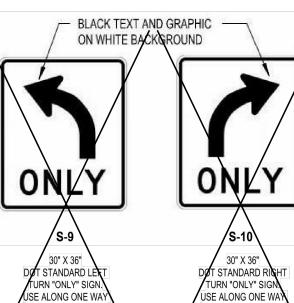

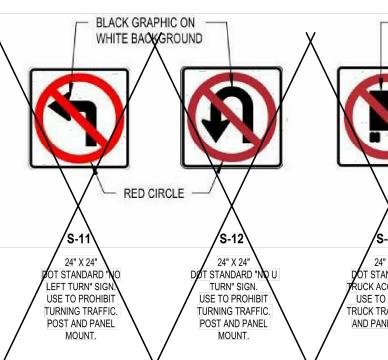


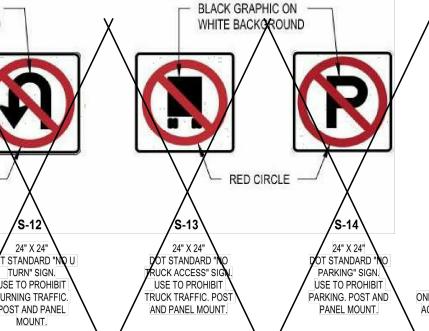

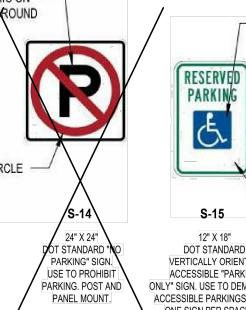


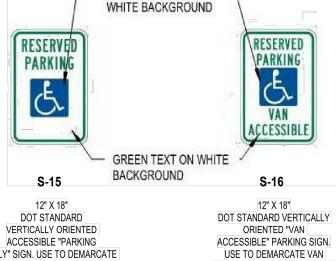


BLUE GRAPHIC ON -

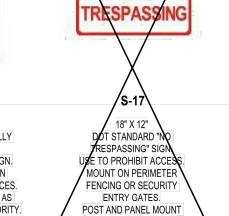


RED TEXT ON

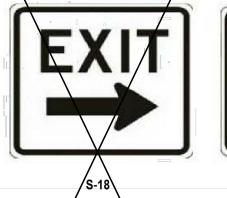



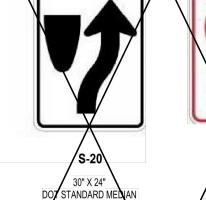

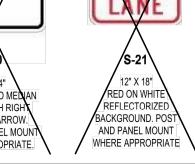

NOTE: ALL CROSSED OUT DETAILS ARE NOT USED ON PROPOSED SITE LAYOUT PLAN, SEE SHEET C2.2


PEDESTRIAN CROSSING OP" SIGN, LEFT ARRO USE AT PEDESTRIAN CROSSWALKS LOCATE IN THE MIDDLE OF DRIVE AISLES. POST AND PANEL


MOUNT.

PEDESTRIAN CROSSING VERTICALLY ORIENTED STOP" SIGN, RIGHT ARR "ONE WAY" LEFT USE AT PEDESTRIAN ARROW SIGN. CROSSWALKS LOCATED II USE ALONG ONE WAY THE MIDDLE OF DRIVE DRIVE AISLES, POST


AISLES. POST AND PANEL

MOUNT.

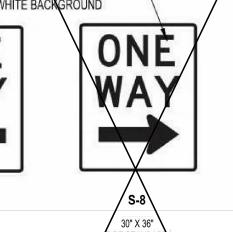

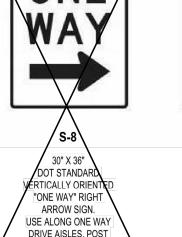


AND PANEL MOUNT.

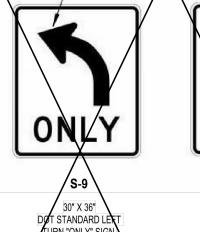



DRIVE AISLES. POST

AND PANEL MOUNT



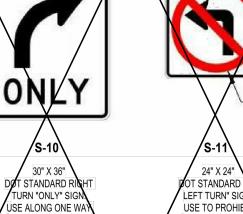

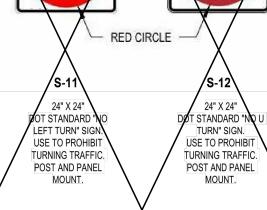

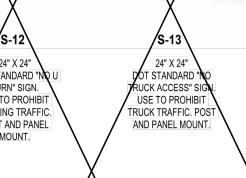

ONLY" SIGN. USE TO DEMARCATE ACCESSIBLE PARKINGSPACES. ONE SIGN PER SPACE OR AS REQUIRED BY LOCAL AUTHORITY. POST AND PANEL MOUNT.

ACCESSIBLE" PARKING SIGN. USE TO DEMARCATE VAN ACCESSIBLE PARKING SPACES. ONE SIGN PER SPACE OR AS REQUIRED BY LOCAL AUTHORITY POST AND PANEL MOUNT.

WHERE APPROPRIATE.

DOT STANDARD "EXIT" SIGN, RIGHT ARROW. POST AND PANEL MOUNT WHERE APPROPRIATE.

30" X 36" LEFT ARROW. POST AND PANEL MOUNT WHERE APPROPRIATE.

DOT STANDARD "EXIT" SIGN,

DOT STANDARD MEDIAN SYMBOL WITH RIGHT DIRECTING ARROW. POST AND PANEL MOUNT WHERE APPROPRIATE.

# CALL 811 NOTE:

CONTRACTOR TO CONTACT 811 SERVICE AT LEAST 3 WORKING DAYS PRIOR TO CONSTRUCTION, TO CONFIRM LOCATION OF EXISTING UTILITIES. DIAL 811.

# PLANT SCHEDULE

CH. LK. FENCE 13.8' WEST

TREES MV	<u>QTY</u> 11	BOTANICAL / COMMON NAME Malus x zumi `Calocarpa` / Redbud Zumi Crabapple	CONT B & B	<u>CAL</u> 2-1/2"	REMARKS 6` BRANCH HT. MIN. Matched.
NS	7	Nyssa sylvatica / Sour Gum	B & B	2-1/2"	7-8' BRANCH HT. MIN.
TG	10	Tilia cordata `Greenspire` / Greenspire Littleleaf Linden	B & B	2-1/2"	7-8' BRANCH HT. MIN.
ZG	12	Zelkova serrata `Green Vase` / Green Vase Sawleaf Zelkova	B & B	2-1/2"	6' BRANCH HT MIN. MATCHED.

EX CONC —

DECIDUOUS SHADE

TREES FOR PEDESTRIAN

WALKWAY AND PARKING

1.5' WIDE GRAVEL BUILDING

1.5' WIDE GRAVEL BUILDING

1.5' WIDE GRAVEL BUILDING

MAINTENANCE STRIP

DECIDUOUS SHADE

TREES FOR PEDESTRIAN

WALKWAY AND PARKING

REQUIRED STREET -

TREES RELOCATED-

UNDERGROUND UTILITIES

LOWER ROAD

(R.O.W. VARIES)

CONFLICT WITH


CH. LK. FENCE 1.5' NORTH

N 67°47'00" E 260.11'

MAINTENANCE STRIP

MAINTENANCE STRIP

SOUTH FACE CONC. CURB 3.3' NORTH

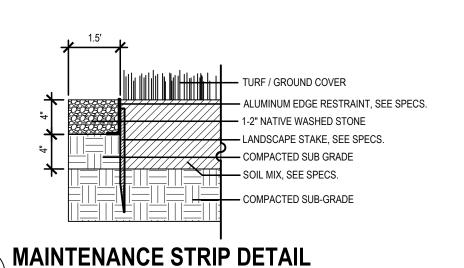

— IRON MARKER FOUND ALONG LINE

BARRIER FREE —

- ENTRANCE SIGN

LANDSCAPE BED

N 77°10'00" E 540.52°

PARKING LOT DECIDUOUS -

SHADE TREES

PARKING SPACES

DECIDUOUS SHADE TREES FOR -

DECIDUOUS SHADE TREES FOR -

1.5' WIDE GRAVEL BUILDING -

COMPACT STREET TREES

-MAX. HEIGHT 20' FOR

OVERHEAD UTILITIES

PEDESTRIAN WALKWAY

MAINTENANCE STRIP

CH. LK. FENCE 2.4' NORTH -

S 67°03'00" W 1,272.86' PARKING LOT SCREENING

----- CH. LK. FENCE MEETS SOUTH FACE CONC. CURB 3.0' NORTH

CH. LK. FENCE 4.7' NORTH

EXISTING BUILDING PROPOSED DELIVERY STATION

ADDRESS: 1800 LOWER ROAD

LOT: 55

17.99 AC

ZONE:

ASPHALT PAVEMENT TO -

N 67°02'00" E

LAWN

**EASEMENT** 

EXISTING WATER MAIN

359.00'

LINDEN, NJ 07036 BLOCK: 580

OWNER: CENTERPOINT LOWER LLC


OAK BROOK, IL 60523

PARKING LOT DECIDUOUS -

TREES SPACED 25' O.C. FOR

PARKING LOT SCREENING


SHADE TREES

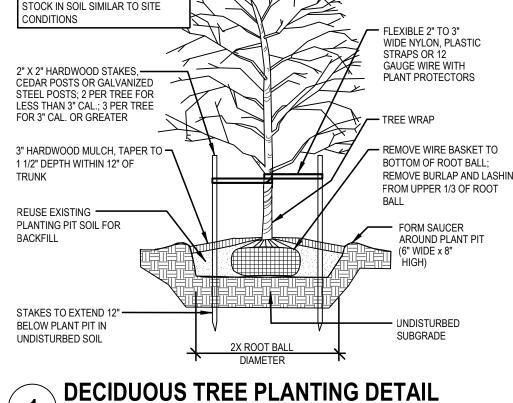

LAWN

ALL PLANTS TO BE NURSERY GROWN

NOT TO SCALE

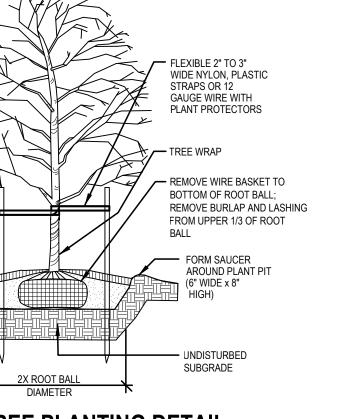


CH. LK. FENCE 28.2' SOUTH -

BARRIERS (TYP)

1 to 101 61(2x)

N 77°26′00" E

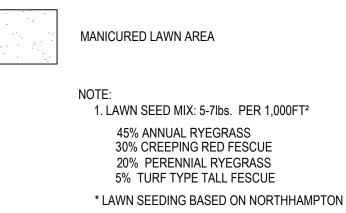

# COUNTY QUICK GREEN LAWN SEED MIXTURE 610-837-6311, \*OR APPROVED EQUAL.

LANDSCAPE LEGEND

SHADE TREES

**EVERGREEN TREES** 

**DECIDUOUS SHRUBS** 

GRAVEL MAINTENANCE STRIP



- CONTRACTOR IS RESPONSIBLE FOR UNDERSTANDING PROJECT CONDITIONS AND VERIFYING PLANT QUANTITIES. NOTIFY LANDSCAPE ARCHITECT OF PLAN
- CONTRACTOR SHALL COMPLY WITH WITH THE BOROUGH OF CARTERET, NEW JERSEY CODE OF ORDINANCES INCLUDING BUT NOT LIMITED TO PROCEDURES, INSPECTIONS, AND MAINTENANCE.
- PLANT LOCATIONS TO BE STAKED IN THE FIELD FOR REVIEW AND APPROVAL BY LANDSCAPE ARCHITECT AND OWNER. CONTRACTOR WILL BE RESPONSIBLE FOR VERIFYING ALL EXISTING UNDERGROUND UTILITIES. CONTACT THE APPROPRIATE UTILITY COMPANY FOR FIELD STAKING ALL LINES.
- 4. ALL AREAS DISTURBED BY CONSTRUCTION TO BE TOPSOILED AND SEEDED UNLESS SHOWN OTHERWISE IN PLANS. SEE SPECIFICATIONS.
- CONTRACTOR TO CONTACT MISS DIG AT PHONE NUMBER 811 AT LEAST 3 WORKING DAYS PRIOR TO CONSTRUCTION TO CONFIRM LOCATION OF EXISTING UTILITIES.
- NOTIFY LANDSCAPE ARCHITECT IF AREAS OF POOR DRAINAGE OR OTHER UNUSUAL SUB-GRADE CONDITIONS ARE ENCOUNTERED DURING EXCAVATION FOR PLANTING PITS.
- 7. LANDSCAPE BEDS TO RECEIVE 2" OF HARDWOOD MULCH. TREE SAUCERS TO RECEIVE 3" OF HARDWOOD MULCH.
- 8. ALL LANDSCAPE BEDS TO HAVE ALUMINUM EDGING. (SEE SPECIFICATIONS)
- TREES AND SHRUBS SHALL BE PLANTED APPROXIMATELY 2" ABOVE GRADE (SEE SPECIFICATIONS AND DETAILS).
- 10. TREES AND SHRUBS WITH CIRCLING, GIRDLING, OR CONTAINER BOUND ROOTS SHALL NOT BE ACCEPTED FOR PLANTING.
- 11. TREES TO BE A PLANTED A MINIMUM OF 6' FROM PAVEMENT EDGES UNLESS OTHERWISE SHOWN.
- 12. PLANTING MIXTURE OF LANDSCAPED BEDS TO BE 4" DEPTH OF TOPSOIL. UNLESS OTHERWISE NOTED. TOPSOIL AND MULCHES TO BE FREE OF NOXIOUS WEEDS AND DISEASED MATERIALS.
- 13. CONTRACTOR SHALL PROVIDE SPECIFIED SHRUBS, GROUND COVERS, AND OTHER PLANT MATERIALS THAT COMPLY WITH ALL RECOMMENDATIONS AND REQUIREMENTS OF ANSI Z60.1 "AMERICAN STANDARD FOR NURSERY STOCK". PLANT MATERIAL SHALL BE HEALTHY, VIGOROUS STOCK, GROWN WITH GOOD HORTICULTURAL PRACTICE AND INSTALLED IN ACCORDANCE WITH METHODS ESTABLISHED BY THE AMERICAN ASSOCIATION OF NURSERYMEN.
- 14. NOTIFY LANDSCAPE ARCHITECT AND OWNER (3 DAYS MIN. NOTICE) TO INSPECT AND TAG PLANT MATERIAL IN THE NURSERY PRIOR TO JOBSITE DELIVERY AND INSTALLATION.

# **ZONING NOTES**

ZONE DISTRICT: LI - LIGHT INDUSTRIAL ADJACENT ZONING: LI- LIGHT INDUSTRIAL

1 REQUIRED SHADE TREE FOR EVERY 50' OF NEW PEDESTRIAN WALKWAYS PROPOSED NEW WALKWAY: 973.5 LF

1 SHADE TREE FOR EVERY 50' OF STREET FRONTAGE FRONTAGE WITHOUT SHADE TREES: 773 LF REQUIRED SHADE TREES: 17 TREES \* 11 FRONTAGE TREES RELOCATED DUE TO CONFLICTS WITH OVERHEAD

1 SHADE TREE FOR EVERY 12 PARKING SPACES \* FOR PROPOSED NEW PAVEMENT AREAS ONLY, NOT FOR EXISTING PARKING NEW PAVEMENT AREA PARKING: 20 SPACES REQUIRED SHADE TREES: 2 TREES

LANDSCAPE BUFFER SCREENING OR FENCE REQUIRED FOR OFF-STREET PARKING AREAS ADJACENT TO ROAD

REQUIRED SHADE TREES: 20 TREES

ELECTRIC WIRES AND UNDERGROUND UTILITIES

TOTAL REQUIRED TREES: 39 TREES TOTAL PROPOSED TREES 40 TREES

SOIL TYPE: URBAN LAND: SANDY TO SILTY LOAM, SOMEWHAT POORLY DRAINED. HIGH RUN OFF CLASS, 6-24" TO WATER TABLE, 18-36" TO FRAGIPAN

# LANDSCAPE PLAN

└\_P.O.B. `

LANDSCAPE PLAN

liability associated with it where the

**ISSUANCE** 

03/17/2020

**REVISIONS** 

FILE NUMBER

**PROFESSIONAL** 

DRAWN BY

CHECKED BY

PROJECT MANAGER

PLANNING AND ZONING

NO. DATE DESCRIPTION

enticity of any digital or electronic seal of ature has not been validated in this manne